Camp W.G. Williams Buildings 5080 & 5100

Utah 84065-4999

DRAWING INDEX:

	COVER SHEET	PG101	PLUMBING GENERAL NOTES AND LEGEND
G1002	GENERAL NOTES, SYMBOLS, ABBREVIATIONS & WALL	PD101	PLUMBING DEMOLITION PLAN
	TYPES	PE101	PLUMBING PLAN
		PE501	PLUMBING DETAILS AND SCHEDULES
AS101	ARCHITECTURAL SITE PLAN	PE502	PLUMBING DETAILS AND SCHEDULES
AD101	DEMOLITION ELOOP DI ANI	MC001	MECHANICAL NICTES AND LECEND
	DEMOLITION FLOOR PLAN	MG001	MECHANICAL NOTES AND LEGEND
AD102	DEMOLITION REFLECTED CEILING PLAN	MD101	MECHANICAL DEMOLITION PLAN
AD103	DEMOLITION ROOF PLAN	ME101	MECHANICAL PLAN
AE101	NEW CONSTRUCTION FLOOR PLAN	ME501	MECHANICAL DETAILS
AE102	NEW CONSTRUCTION REFLECTED CEILING PLAN	ME502	MECHANICAL DETAILS
AE103	NEW CONSTRUCTION ROOF PLAN	ME503	MECHANICAL DETAILS
AE201	EXTERIOR ELEVATIONS	ME601	MECHANICAL SCHEDULES
AE202	EXTERIOR ELEVATIONS		
AE401	ENLARGED FLOOR PLAN	ES101	ELECTRICAL SITE PLAN
AE402	INTERIOR ELEVATIONS	ED101	ELECTRICAL DEMOLITION PLAN
AE501	DETAILS	E-101	NEW ELECTRICAL LIGHTING PLAN
AE502	DETAILS	E-102	NEW ELECTRICAL EQUIPMENT PLAN
AE601	DOOR, WINDOW AND FINISH SHEDULES	E-601	ELECTRICAL RISERS AND WIRING DIAGRAN
		E-602	ELECTRICAL SCHEDULES AND SYMBOL LIST
FS101	NEW FOOD SERVICE LAYOUT		
		FA101	NEW FIRE ALARM SYSTEM PLAN

MAY 2008



State of Utah - Department of Administrative Services

DIVISION OF FACILITIES CONSTRUCTION AND MANAGEMENT

4110 State Office Building / Salt Lake City, Utah 84114 / 538-3018

DFCM PROJECT NO. 07332480 CONTRACT NO. 087184 ajc PROJECT NO. 0781




703 east 1700 south salt lake city, utah 84105 telephone: 801-466-8818 fax: 801-466-4411 email: ajc@ajcarchitects.com

APPROVALS:

DFCM

Prime Agency

PPROVAL DOES NOT RELIEVE A/E OF DESIGN LIABIL

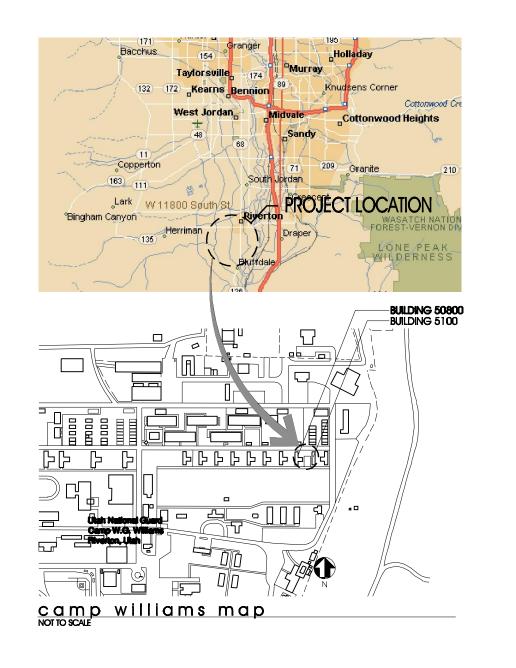

ARCHITECTURAL ajc architects

703 East 1700 South Salt Lake City, Utah 84105 PH#: (801) 466-8818 FAX: (801) 466-4411 CONTACT: Jill A. Jones, AlA

PLUMBING **MECHANICAL** ELECTRICAL WHW Engineering

Thomas & Kolkman 64 West 1700 South Salt Lake City, Utah 84115 1354 East 3300 South Suite 200 Salt Lake City, Utah 84106 PH#: (801) 484-8161 PH#: (801) 466-4021 FAX: (801) 466-8536 FAX: (801) 484-3538 CONTACT: Ray Kolkman **CONTACT: Win Packer**

SCOPE OF WORK

FOR MECHANICAL EQUIPMENT.

THE SCOPE OF WORK FOR THIS PROJECT INVOLVES THE INTERIOR RENOVATION OF BUILDING 5080 AND 5100 (CURRENTLY LABELED AS 5080 AND 5100) THE SCOPE OF THE RENOVATION IS AS FOLLOWS: INTERIOR 1. DEMOLITION OF INTERIOR FINISHES AND EQUIPMENT.

- 2. NEW INTERIOR FINISHES AND EQUIPMENT.
- 3. NEW RESTROOMS.
- 4. NEW MECHANICAL SYSTEMS, INCLUDING NFPA 13 FIRE SPRINKLER SYSTEM 5. NEW ELECTRICAL SYSTEMS.
- 1. PATCH, REPAIR AND REPAINT ALL EXTERIOR FINISHES AREAS
- 2. PROVIDE AND INSTALL NEW STEEL, HISTORICALLY SENSITIVE WINDOWS. 3. PROVIDE AND INSTALL NEW TWO (2) SIDED SCREEN FENCE ENCLOSURE

BASE BID TO INCLUDE ALL WORK CONTAINED WITHIN THE CONSTRUCTION DOCUMENTS EXCEPT THOSE ITEMS LISTED BELOW AND IN THE CONSTRUCTION DOCUMENTS AS ALTERNATE #1.

BASE BID TO INCLUDE ALL WORK CONTAINED WITHIN THE CONSTRUCTION DOCUMENTS EXCEPT THOSE ITEMS LISTED BELOW AND IN THE CONSTRUCTION DOCUMENTS AS ALTERNATE #1.

CODE ANALYSIS

APPLICABLE CODES

	ternational Building Co ternational Mechanica		200 <i>6</i>			2005
	ternational Plumbing C		2006	Building Conser	-	
	ternational Fire Code		2006		ity	2004
	ternational Energy onservation Code		2003	Guidelines		2004
				<u>, </u>		
A.	Occupancy and Grou					
				_ Mixed Occupancy: \all Rise, Covered Mall):		No
В.	Seismic Design Cate	gory:		Design Wind Speed	: <u>90</u>	mph
C.	Type of Construction	(circle	one):			
	• •	•	•	<u>ш</u> <u>ш</u> <u>т</u> нт	<u>▼</u>	$\overline{\underline{\mathbf{Z}}}$
D.	Fire Resistance Ratir separation distance (in hours):	s for the Exterior Walls O West: O	based on	the fire
E.	Mixed Occupancies:	<u>N.A.</u>	_ No	nseparated Uses:		
F:	Sprinklers:					
	Required:	Provide	ed:	Type of Sprinkler Sy	/stem: <u>N</u>	FPA 13
G:	Number of Stories:	1	Building	Height: <u>15' 18-1</u>	<u>/2"</u>	
H:	Actual Area per Floo	or (squa	re feet): _	3,500 GROSS		
l:	Tabular Area: <u>6,00</u>	10 GRC	DSS			
J:	Area Modifications:					
	Га. т.	. Та.]	Гг	٦	W
	a) $A_a = A_t + \frac{\lambda_t + 1}{100}$	-]+[<u>/(</u> 10	00	$I_f = 100 \left[\frac{F}{P} \right]$	- 0.25	30
	b) Sum of the Ratio	Calcula	ations for l	Mixed Occupancies:		
	,			viixed Occupancies.		
	Actual Area Allowable Area	≤ 1				
	c) Total Allowable A	\rea for:				
	1) One Story:					
	-					
	2) Two Story:	_				
	3) Three Story:	A _a (3)_				
	d) Unlimited Area B	uilding:	Yes	No Co	ode Sectio	n:
K.	Fire Resistance Rati	ng Requ	uirements	for Building Elements ((hours).	
Ele	ement	Hours	Assembly Listing	Element	Но	urs Assembly Listing
Ex	terior Bearing Walls	0	· J	Floors - Ceiling Floors		
Inte	erior Bearing Walls	0		Roofs - Ceiling Roofs	-	<u> </u>
	terior Non-Bearing Walls ructural Frame	0		Exterior Doors and Win Shaft Enclosures	40110) .A.
	rtitions - Permanent	0		Fire Walls	Ň	.A.
Fir	e Barriers	N.A.		Fire Partitions		.A.
				Smoke Partitions	N	.A.
L.	Design Occupant Loa	d. 16	3.5			
				tura vari dan ita) 7	
	Exit Width Required:	<u> </u>	<u>∠</u> E	xit Width Provided: 2	210	
М.	Minimum Number of	Require	d Plumbir	na Facilities:		
.41.		-		-	ا المسار الم	ე <u>"</u> 1
	a) vvater Closets - I	≺equired	z (m)	2 (f) 1* Provide	ea (m)	<u> </u>
	<i>b</i> , <u></u>	Aa oa 1.	''' <i>'</i>	(f) 1 Provided	ı (m) <u>2</u>	<u> </u>
	c) Bath Tubs or Sho	_		omijos Cinks. 1		
	ILITARY BASE W/ LAI	RGELY	MALE PC	ervice Sinks:1 PULATION. BY UTAH AIR NATION	GUARD	
N.	Deferred Submittal Li					
	a) Fire Sprinklers: [Build Cale	culations & Drawings		
FOO	TNOTES:	_				
1)	In case of conflict with		=	ent of Justice Federal	_	
1	through ⊻ - ADA Guide	elines ar	nd specific	c reference to the Interr	national Bu	uilding

Code Accessibility Chapters, the more restrictive requirement shall govern.

2) Additional Code Information shall be provided at the discretion of the Building

Official for Complex Buildings. Including, but not limited to:

a) High Rise Requirements.

c) Performance Based Criteria.


e) Fire Assembly Locator Sheet


f) Exterior and Interior Accessibility Route.


g) Fire Stopping, Including Tested Design Number.


d) Means or Egress Analysis.


b) Atriums.

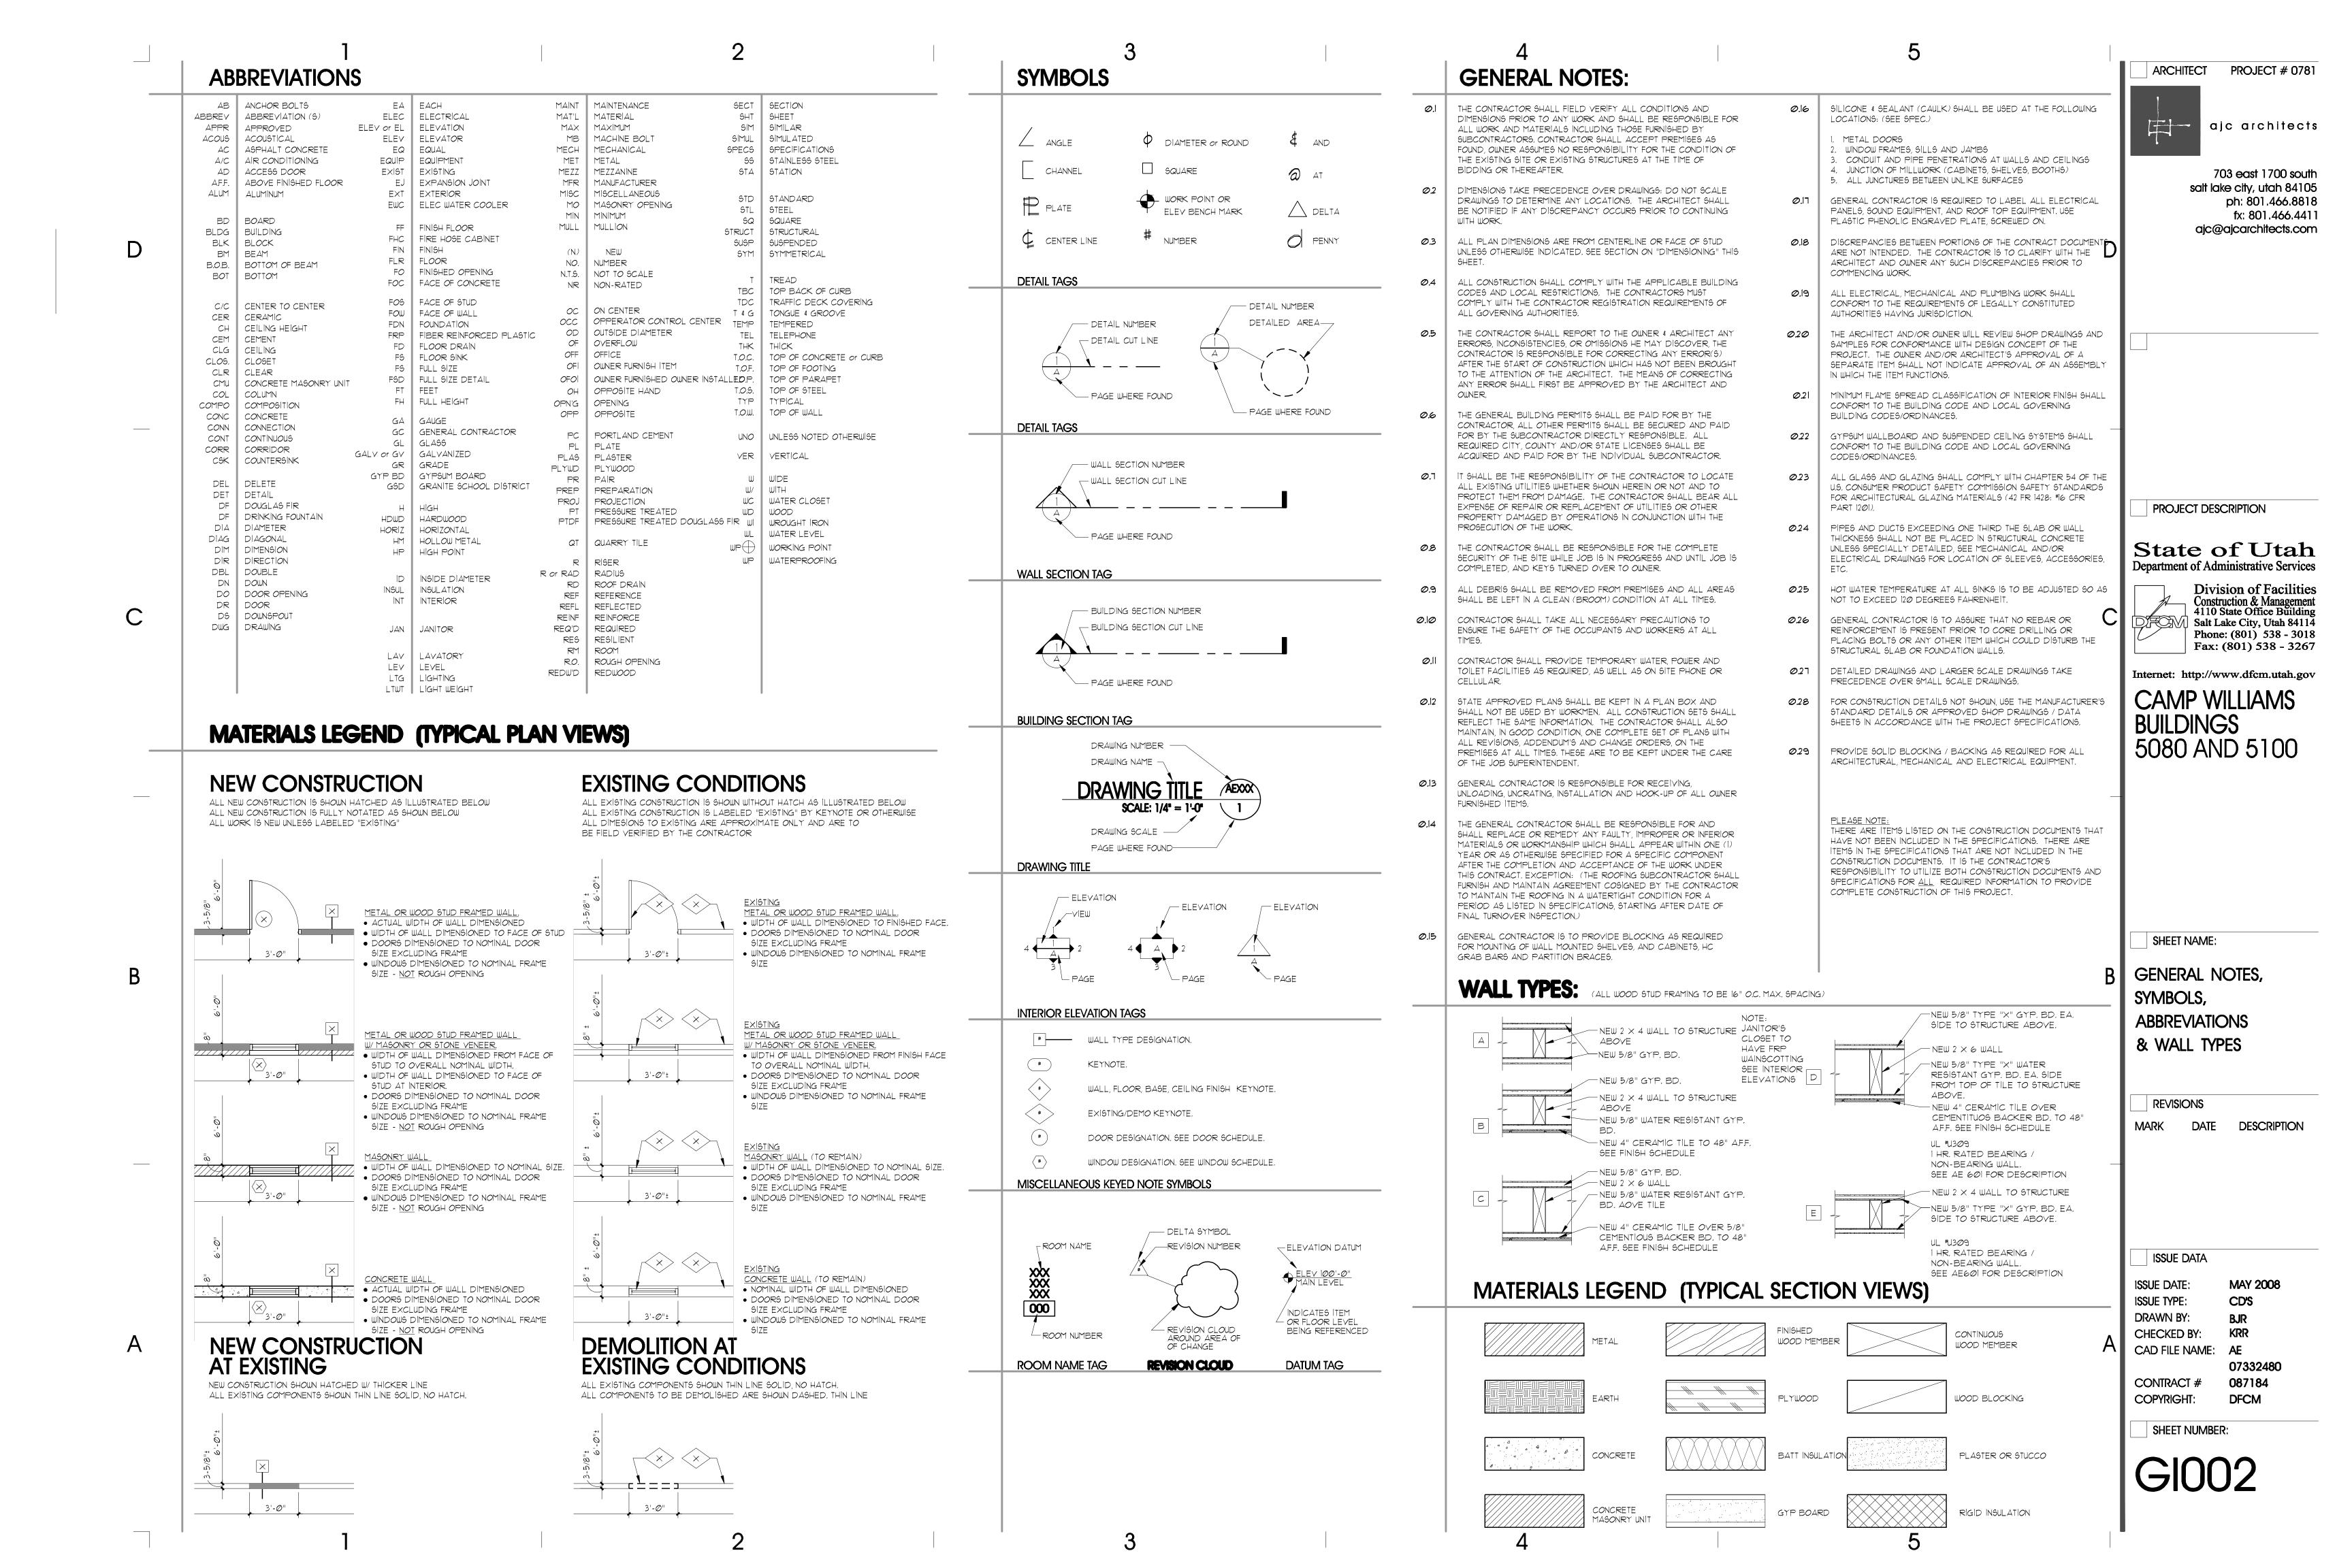


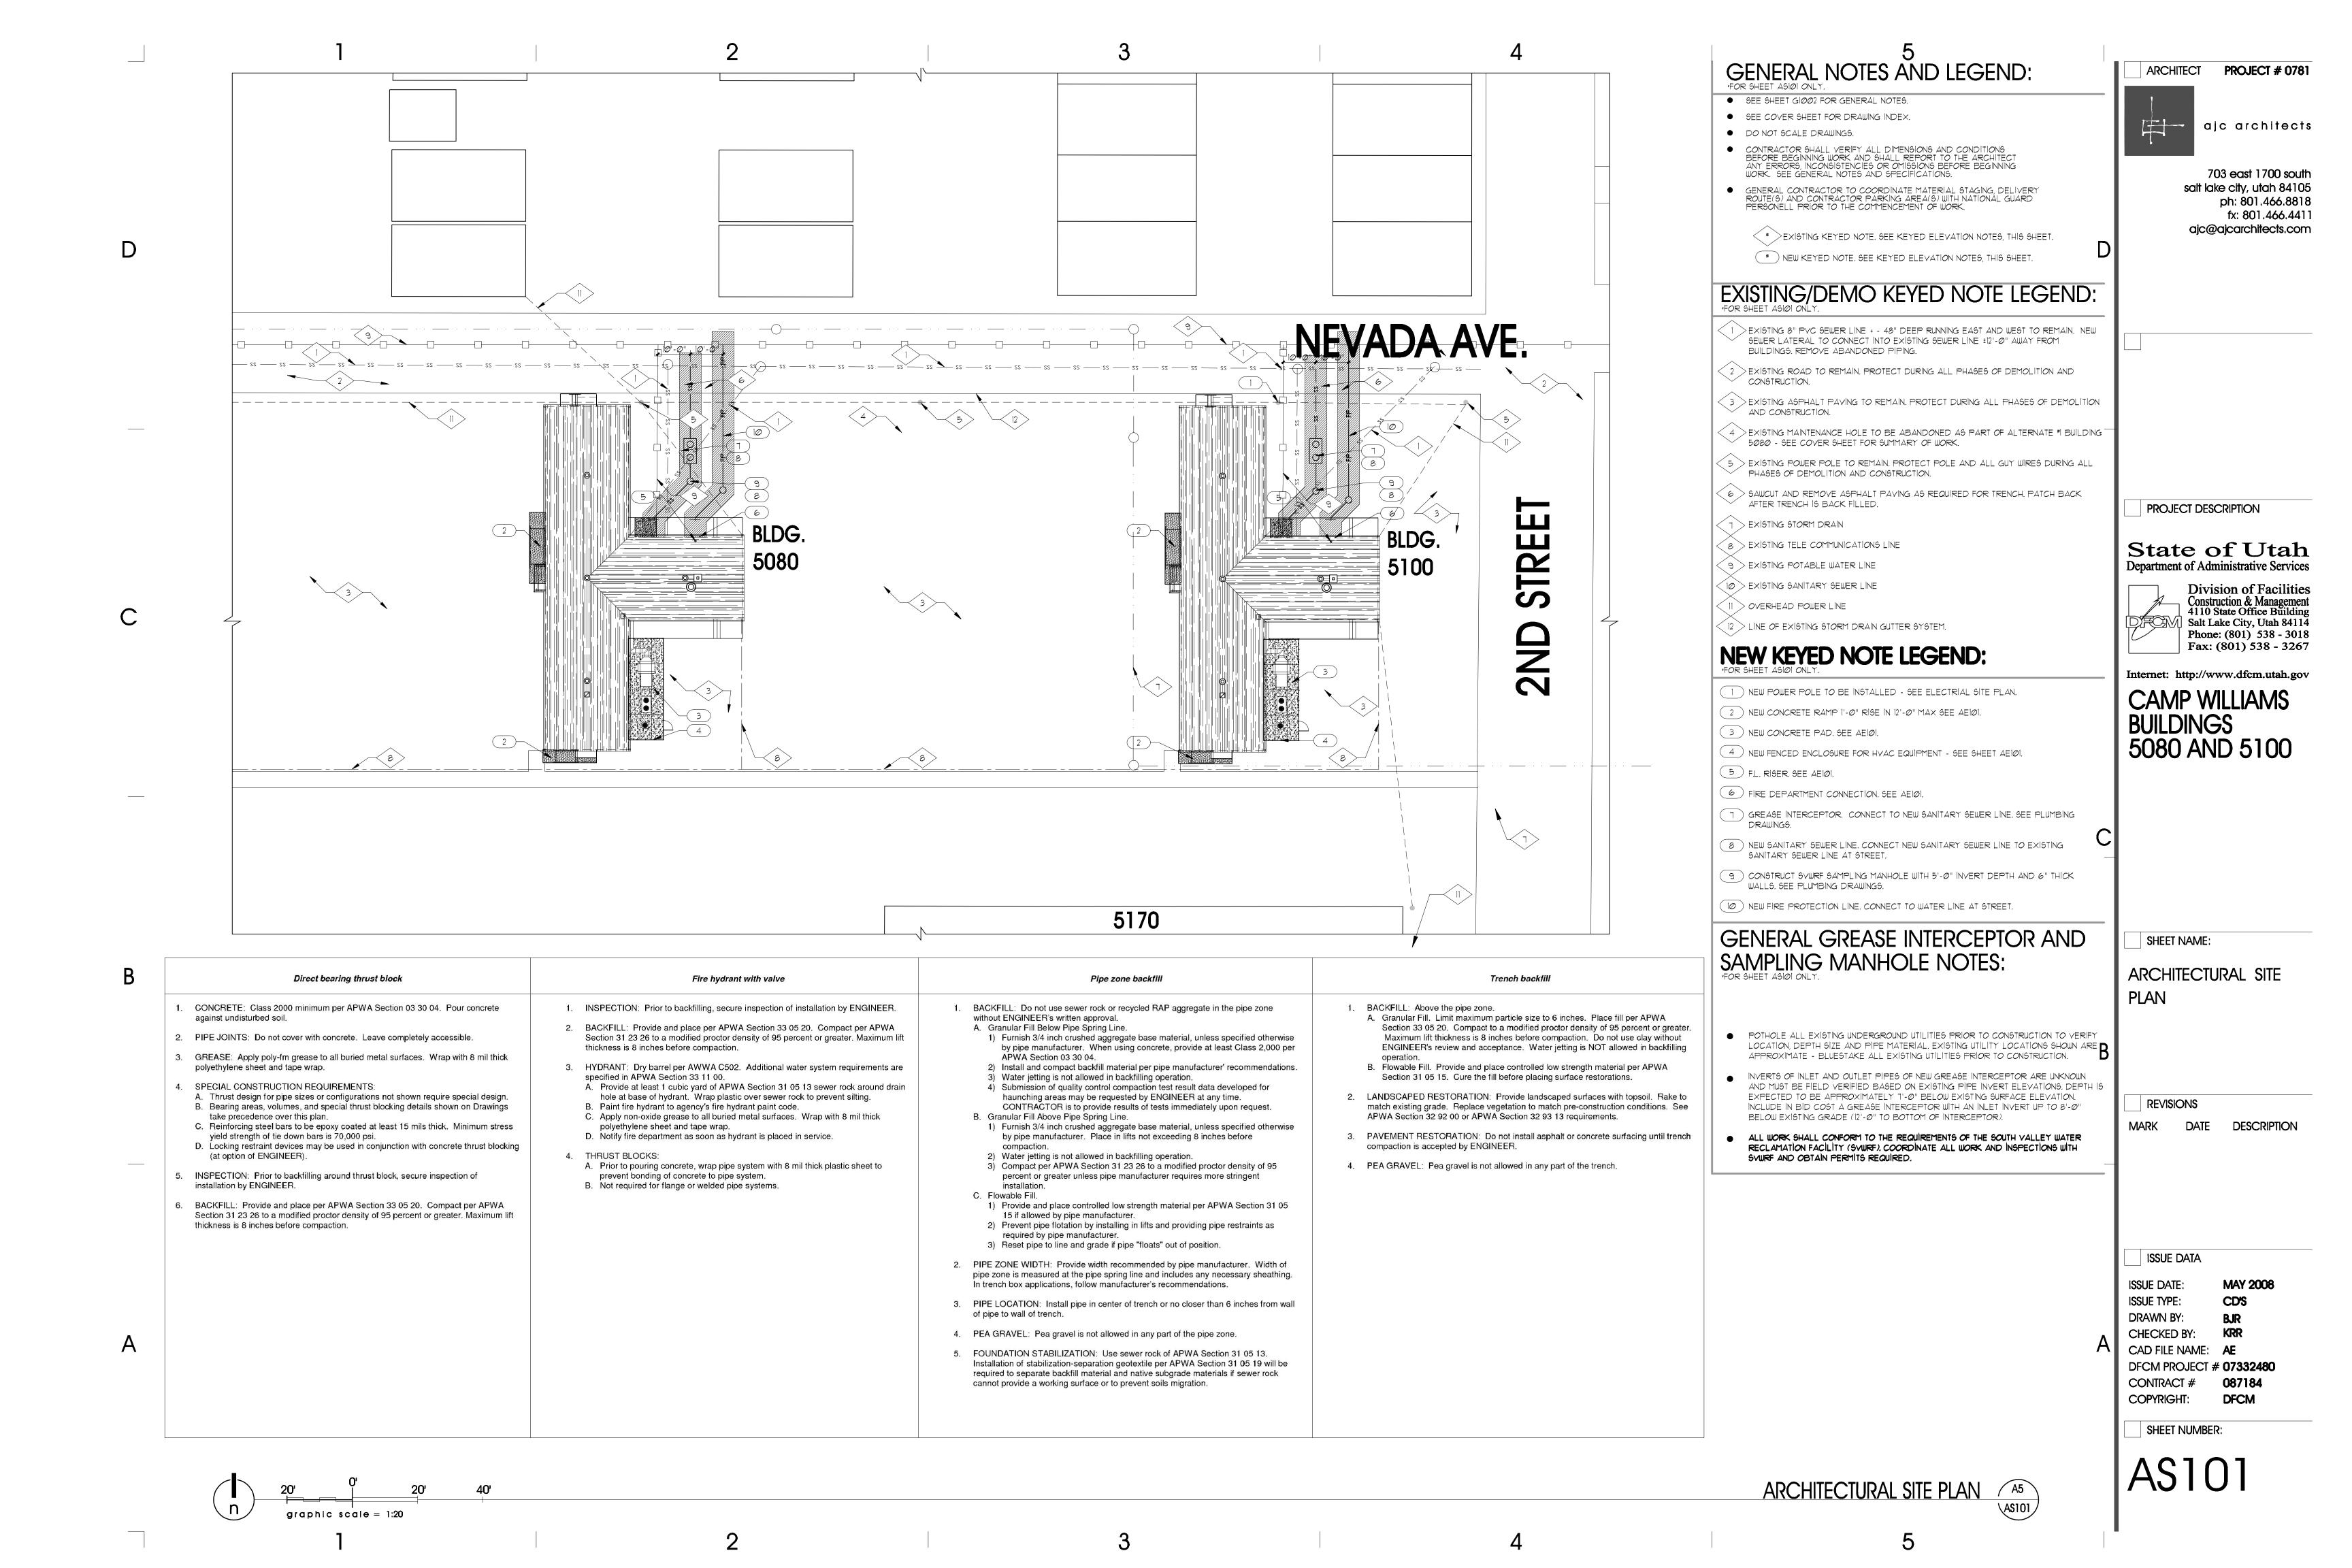


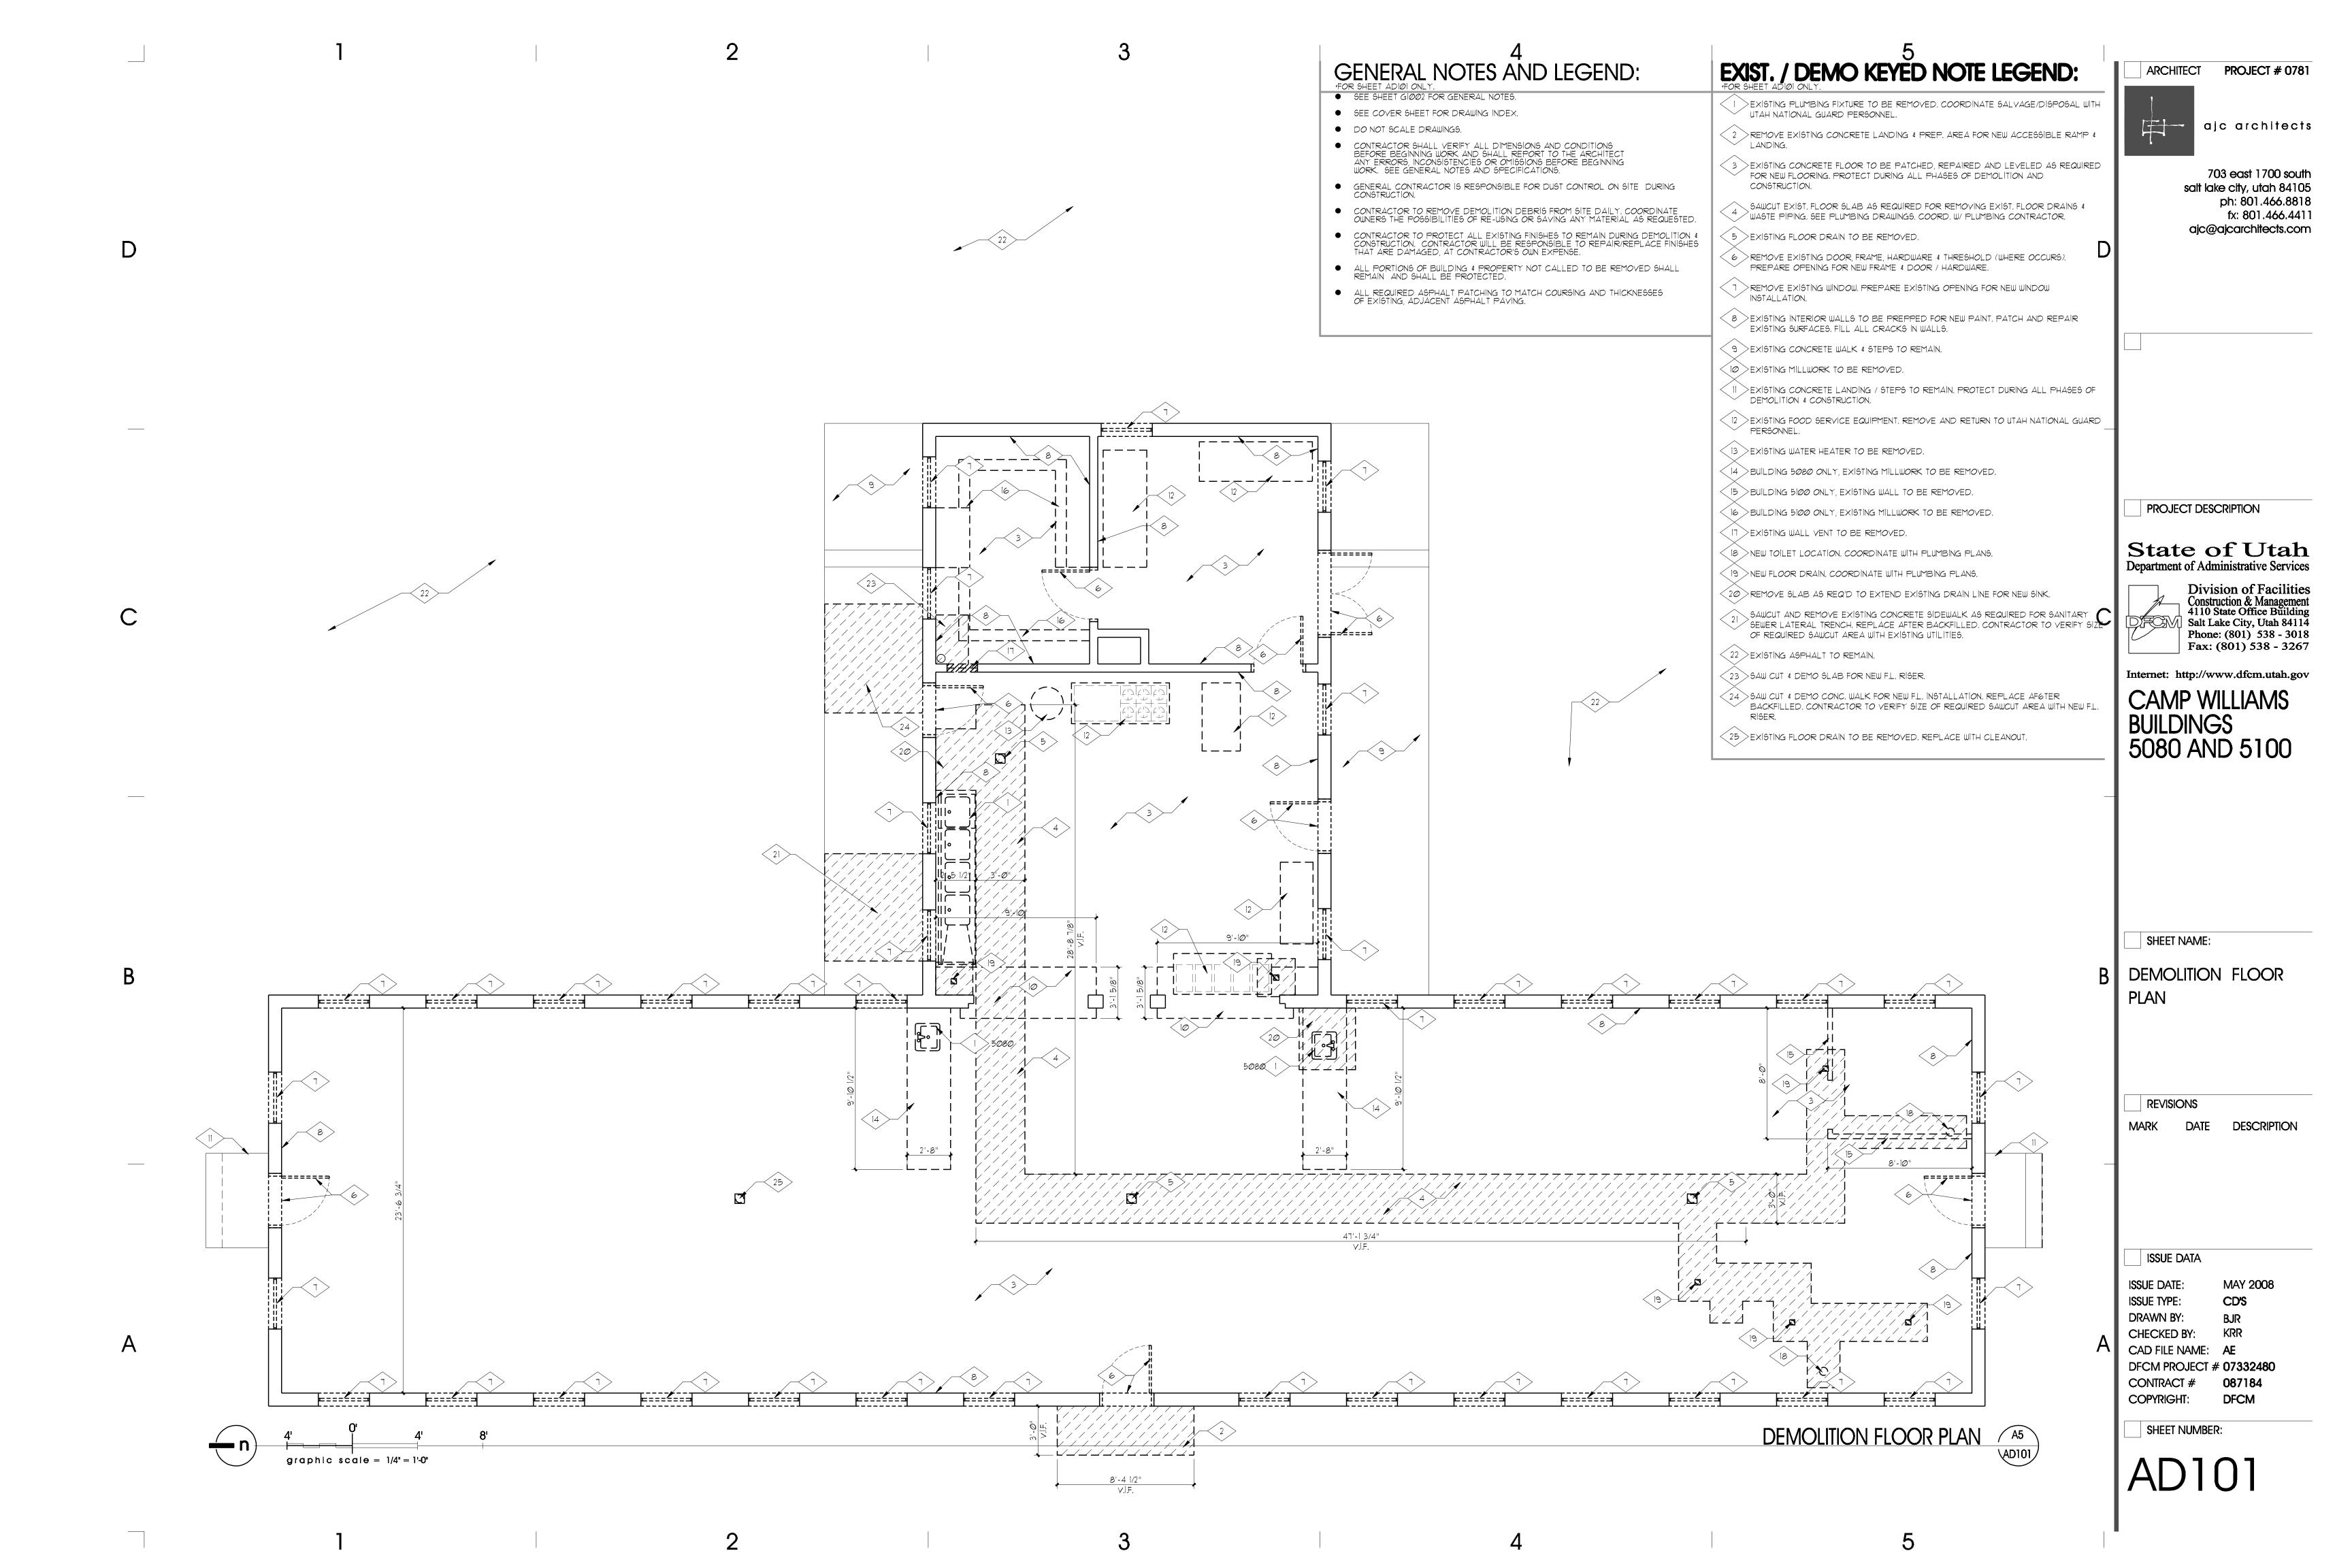


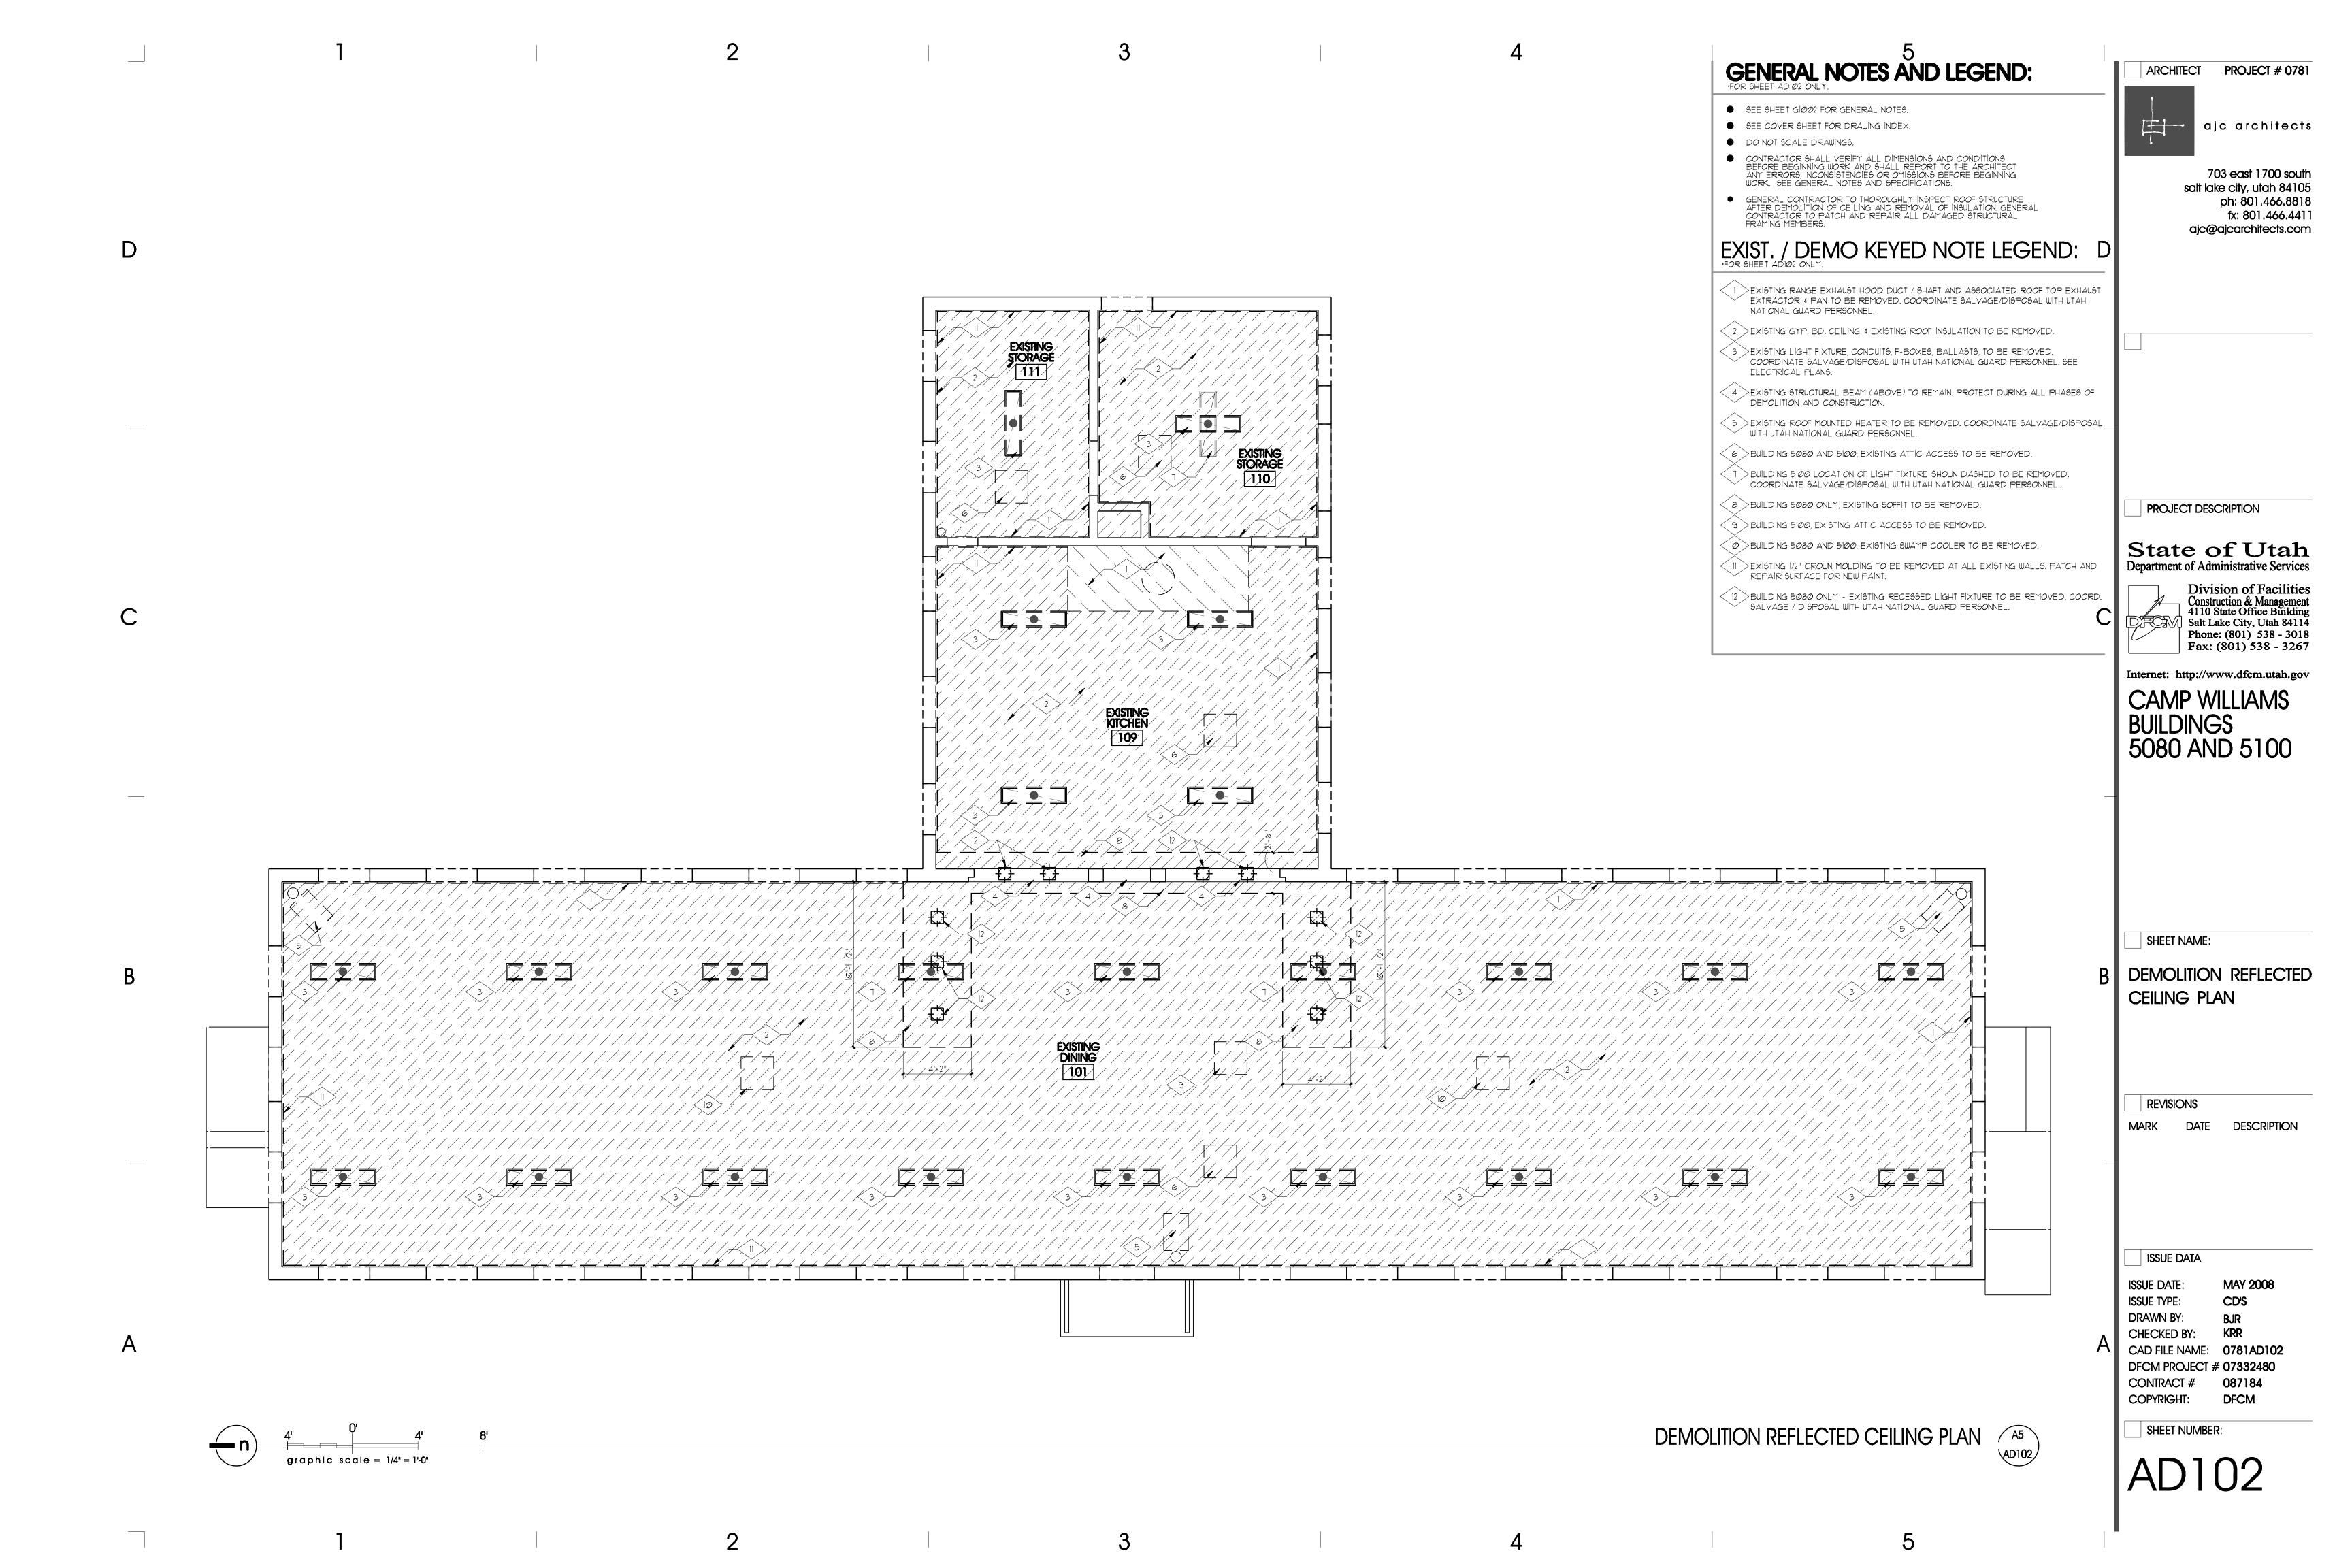


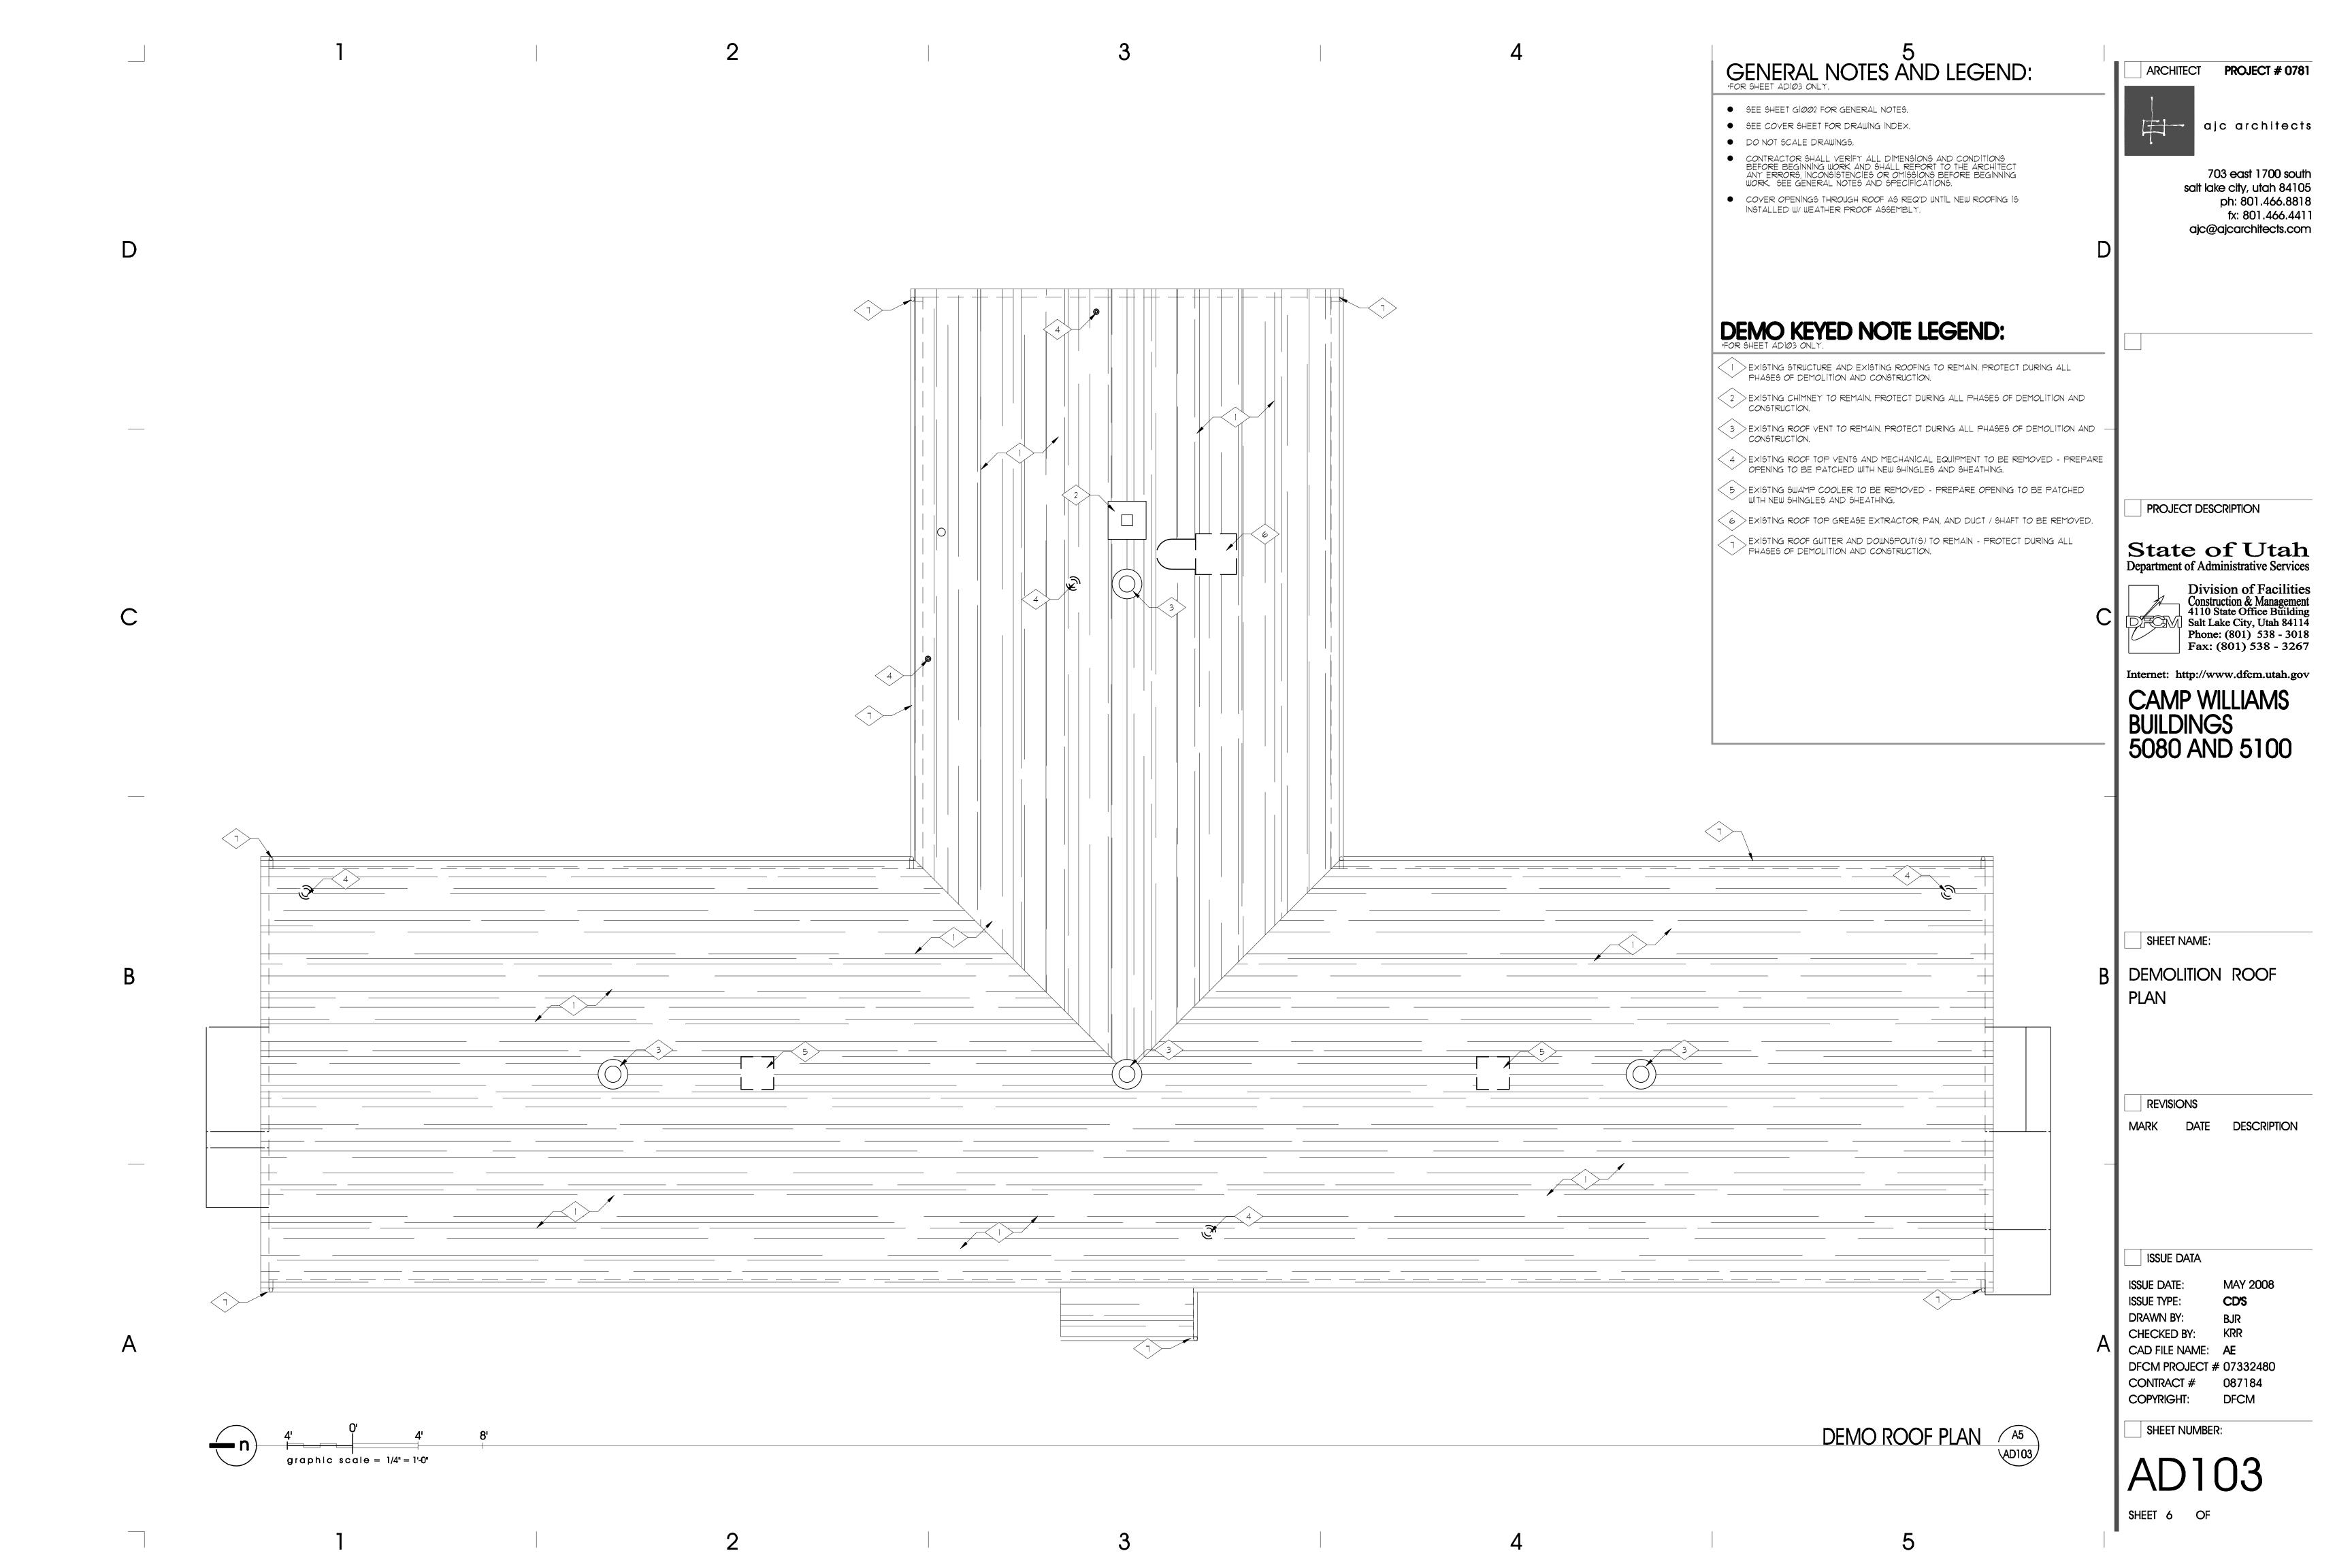

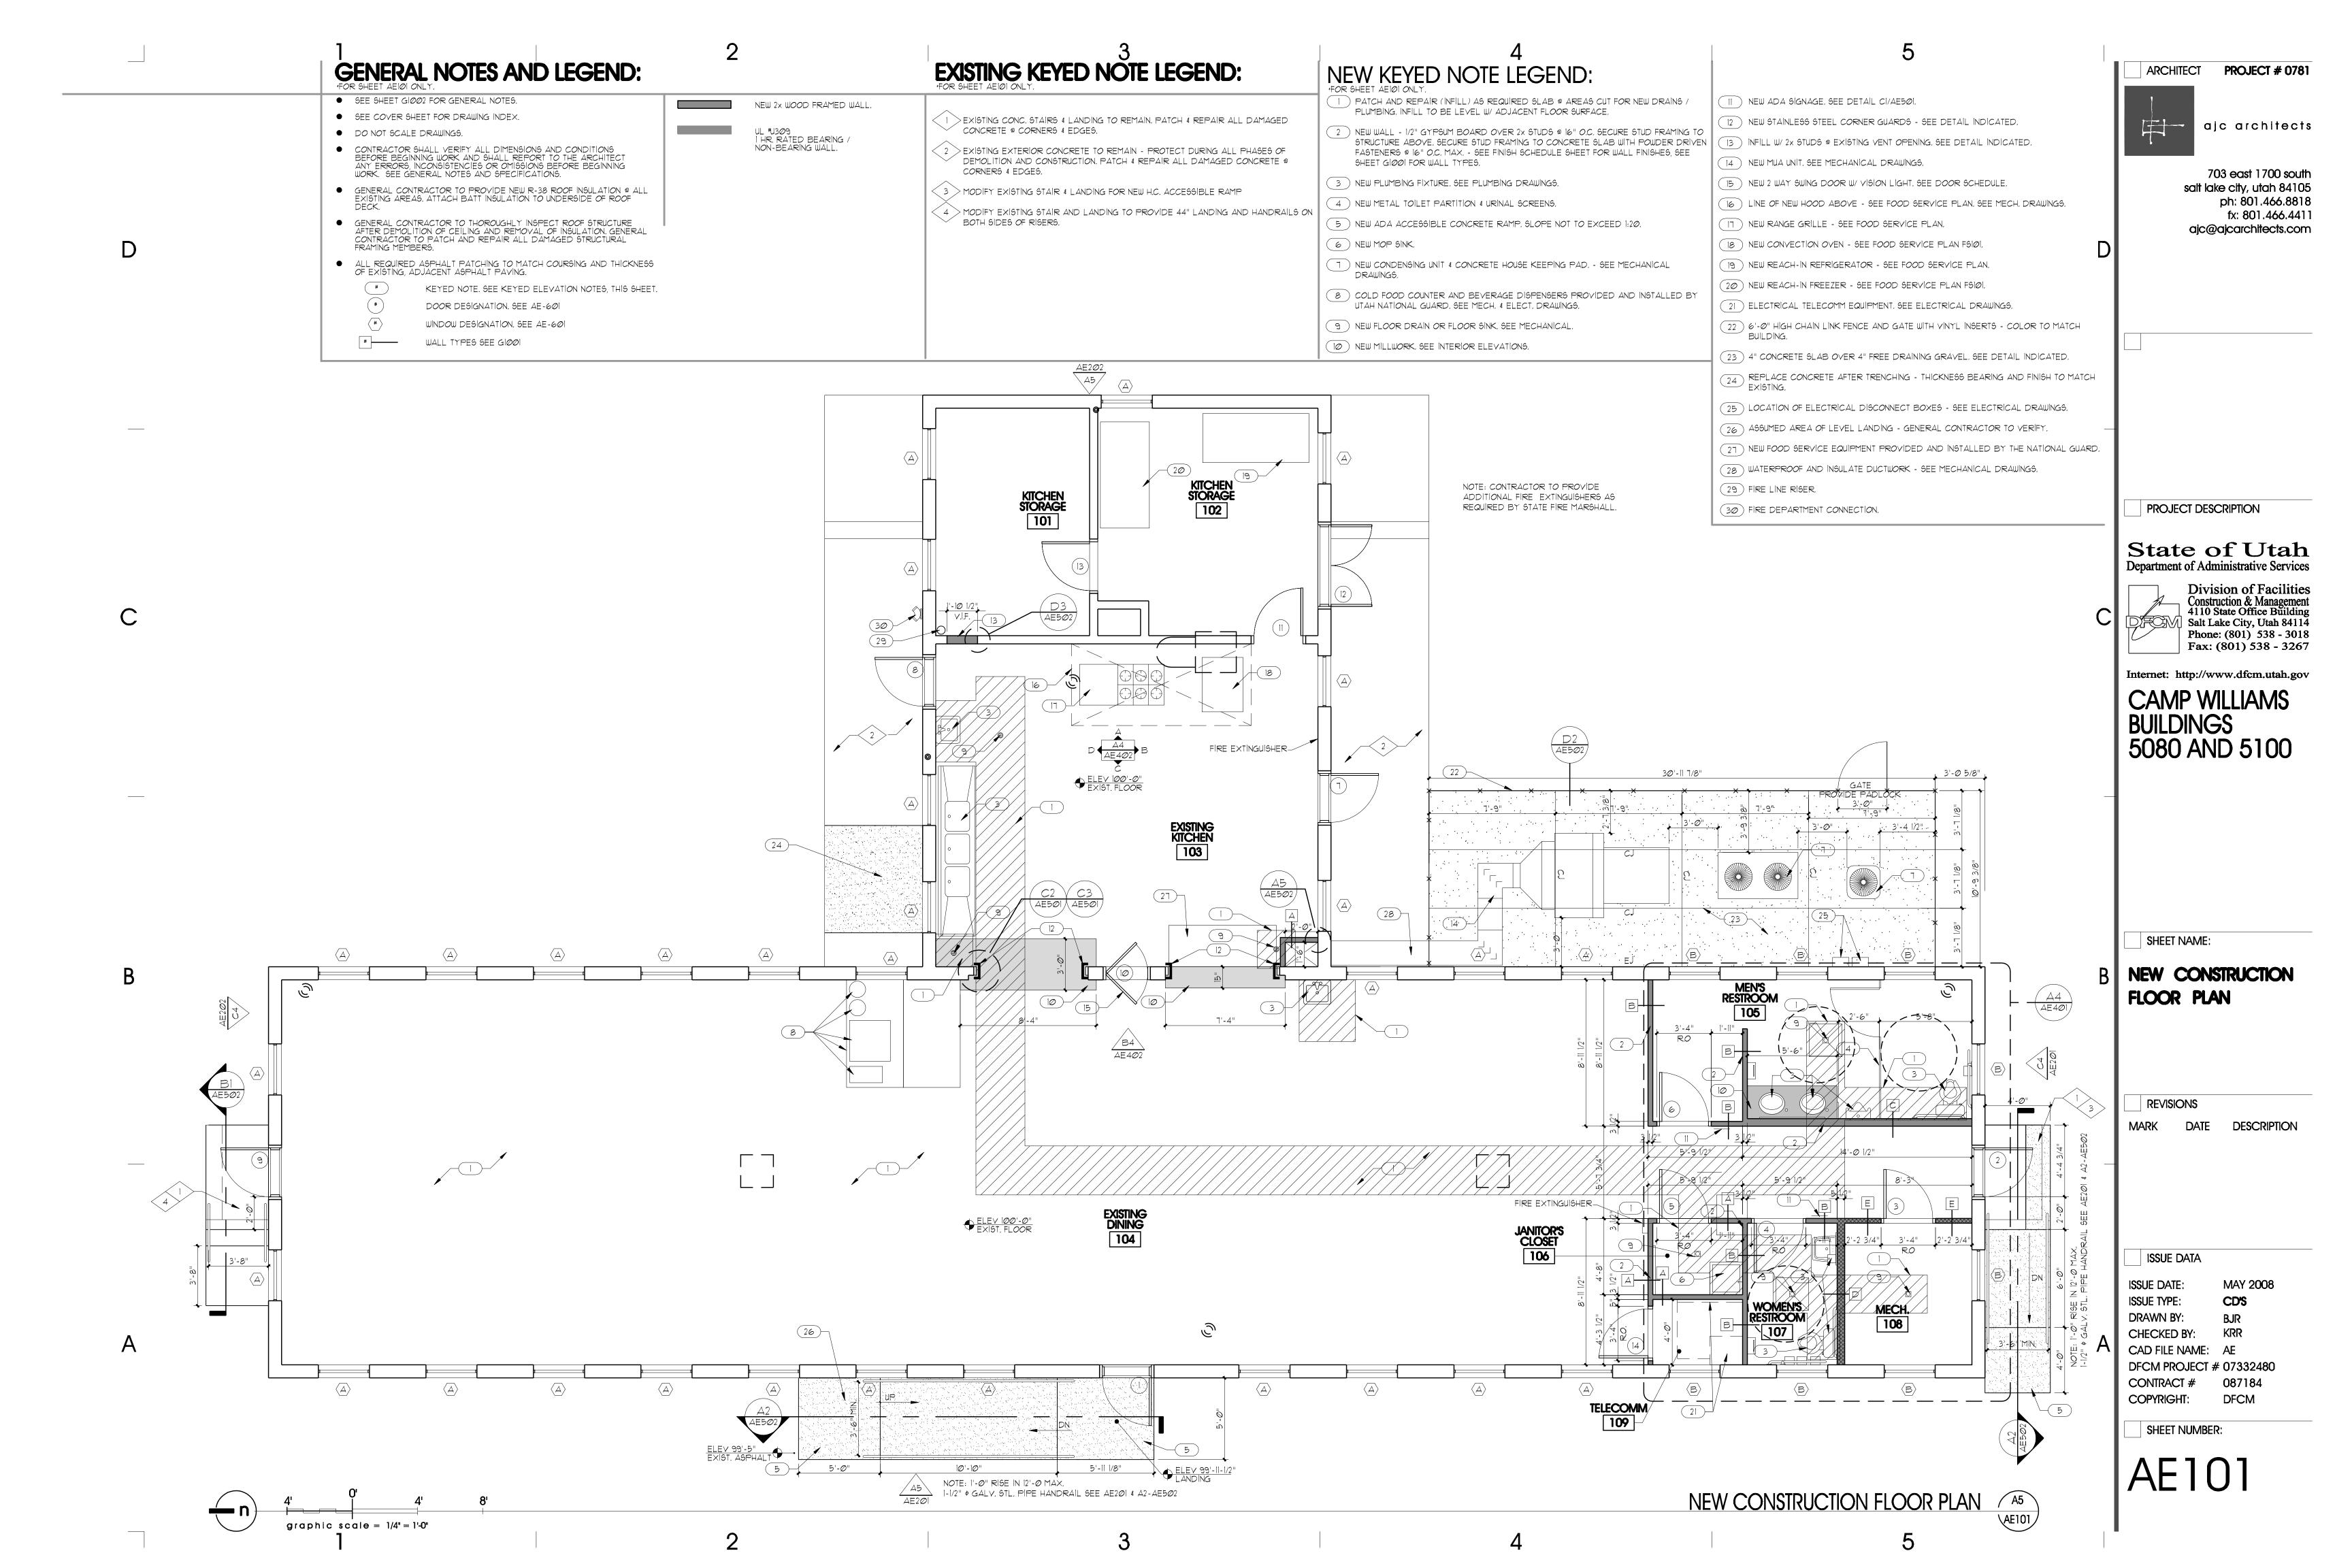

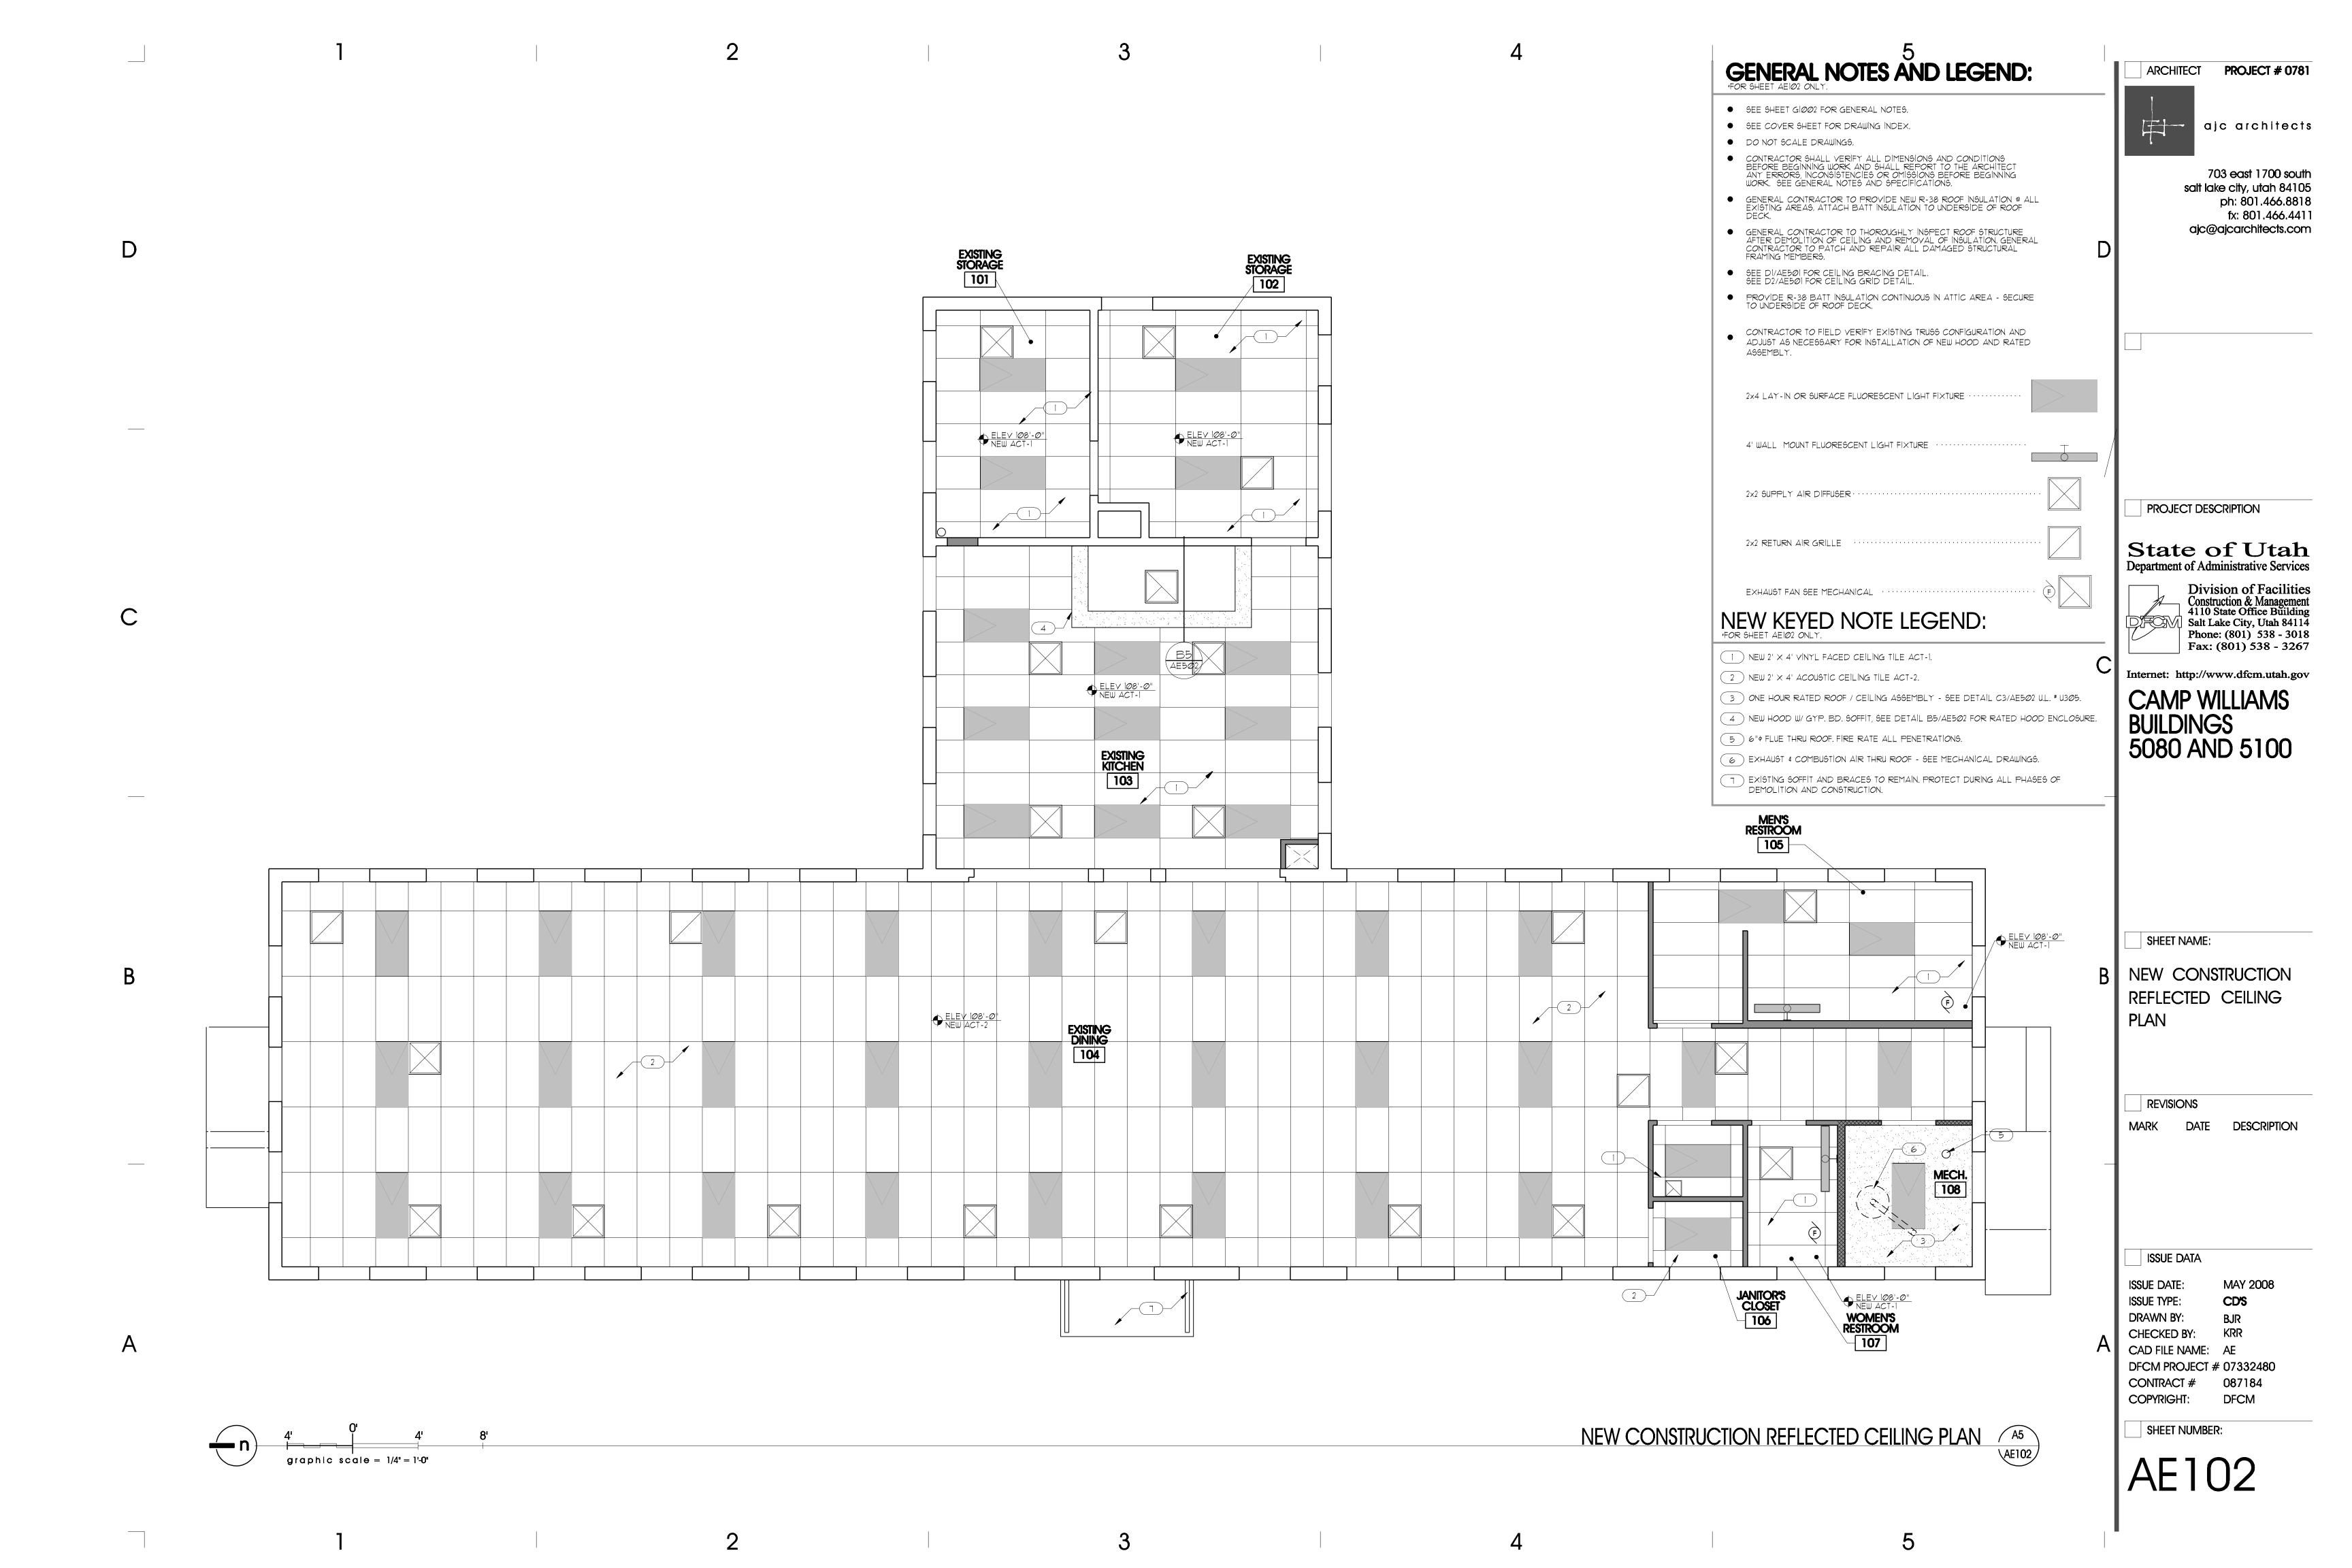

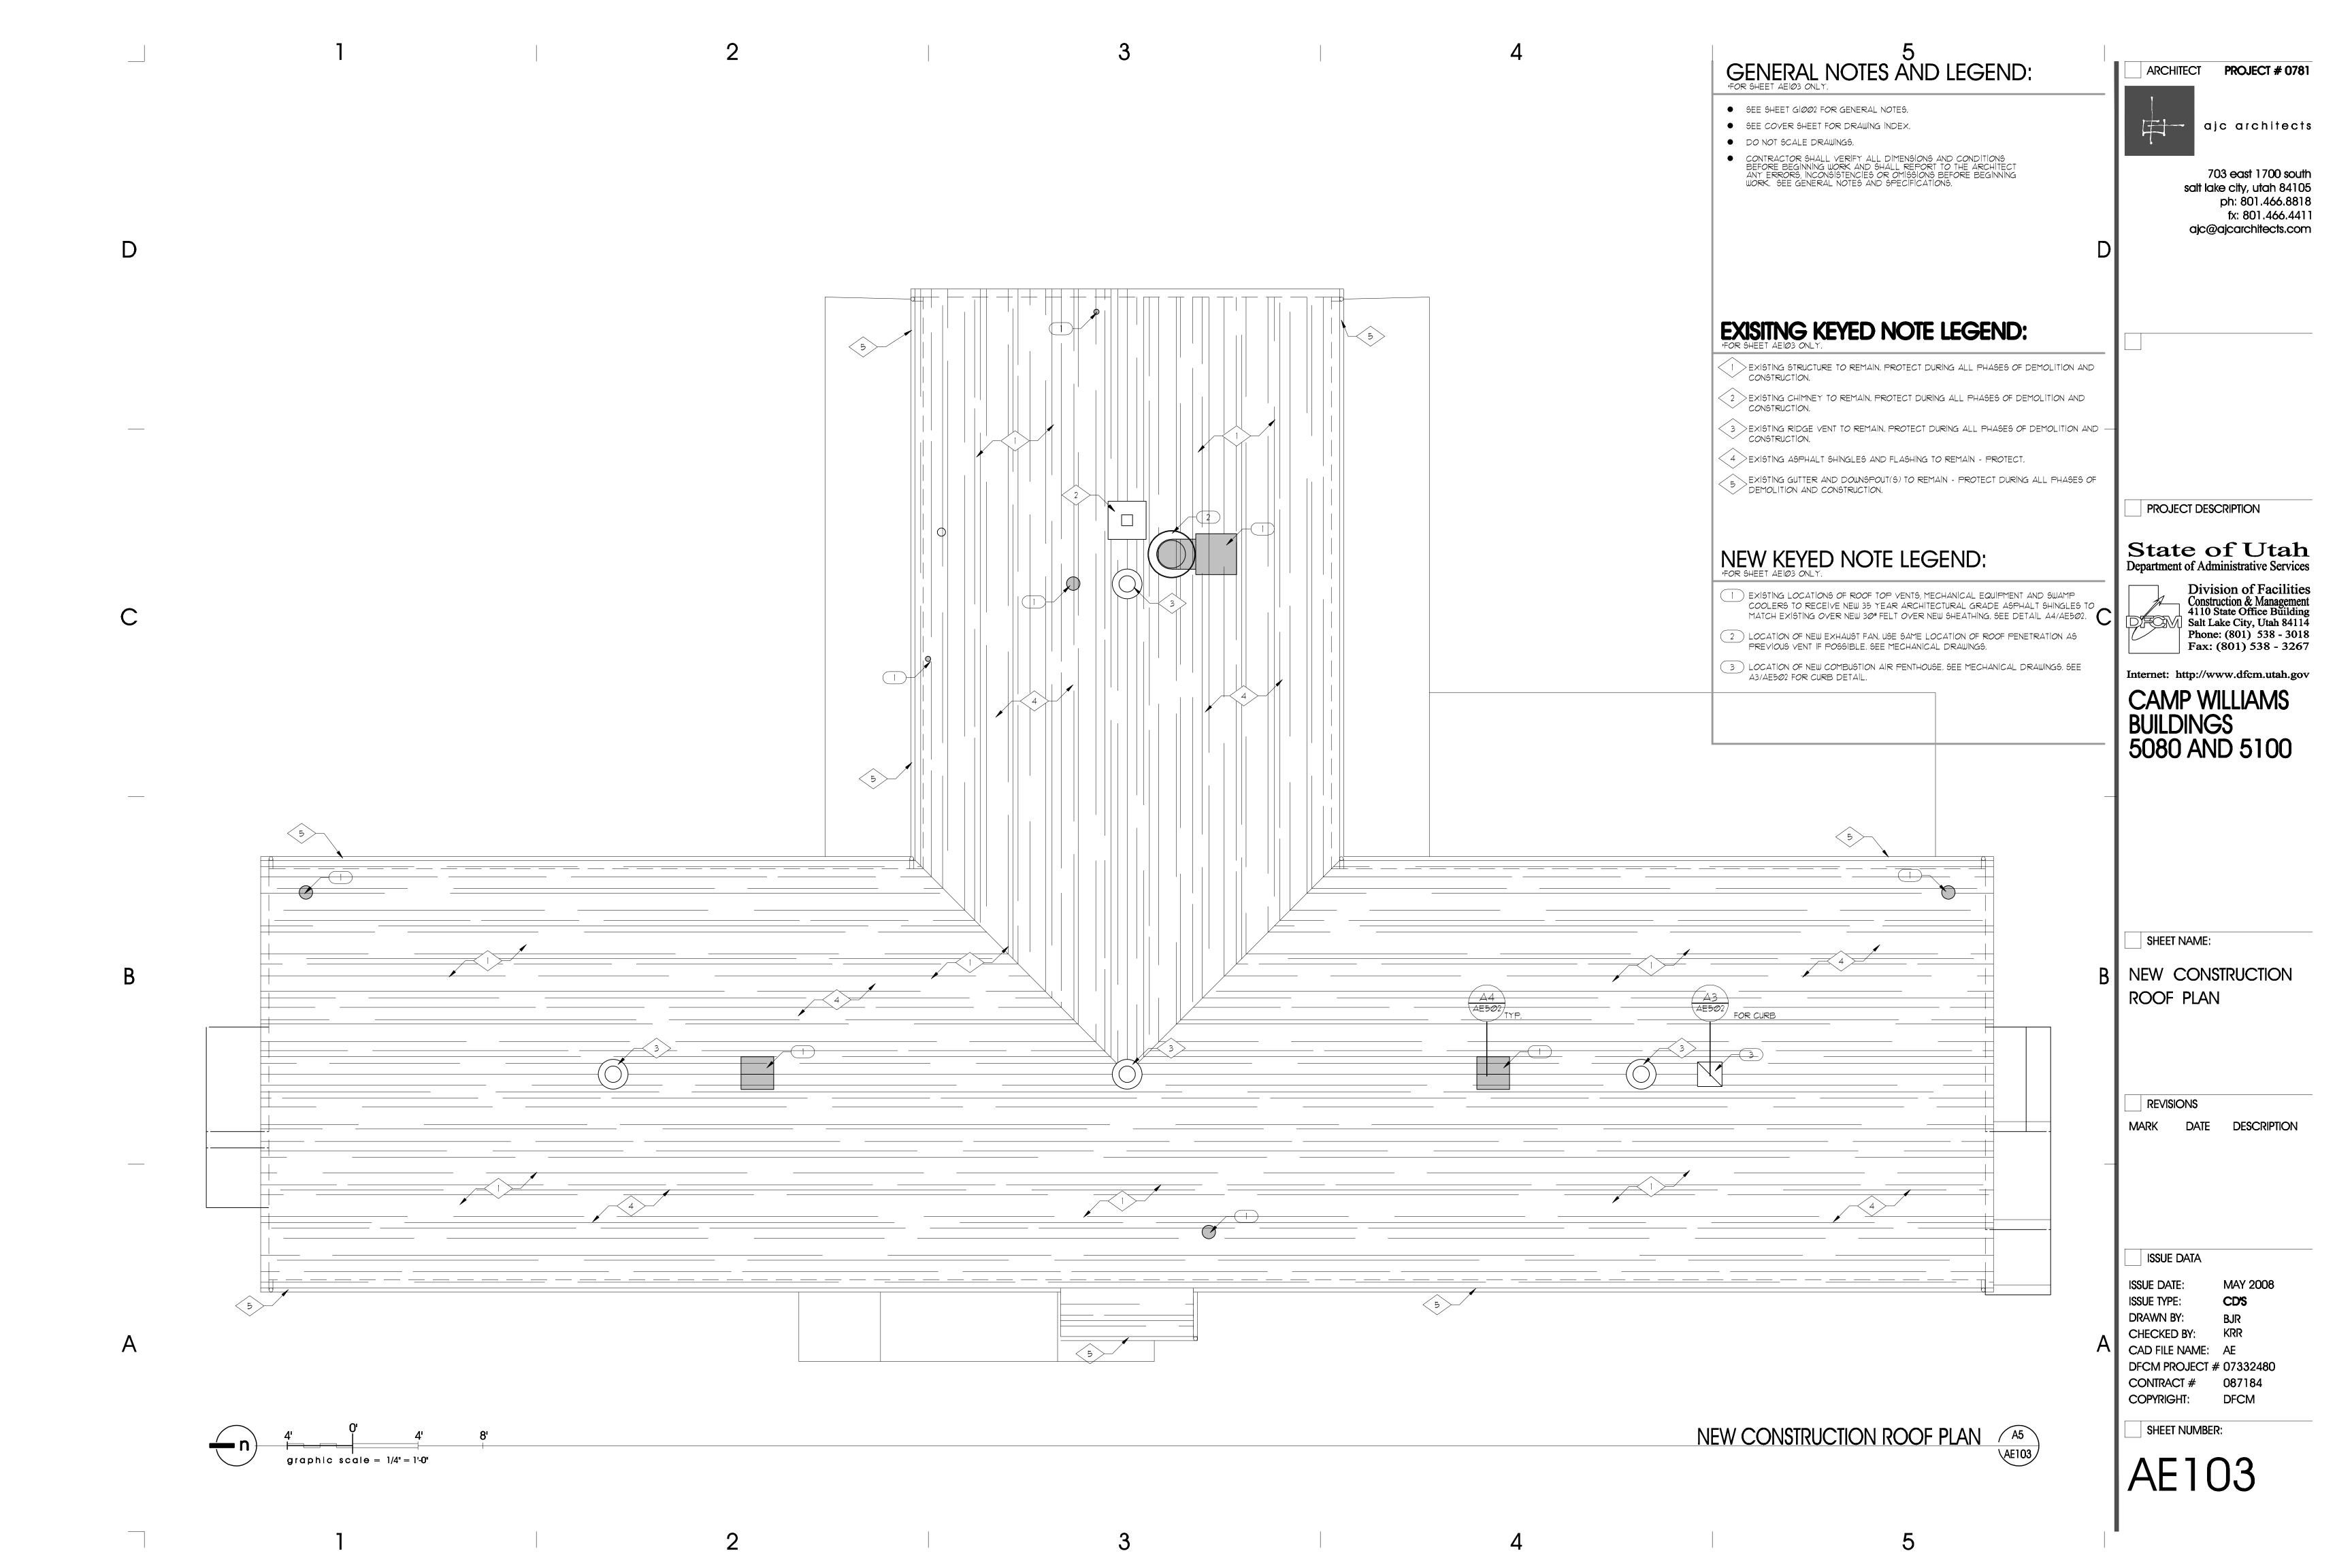

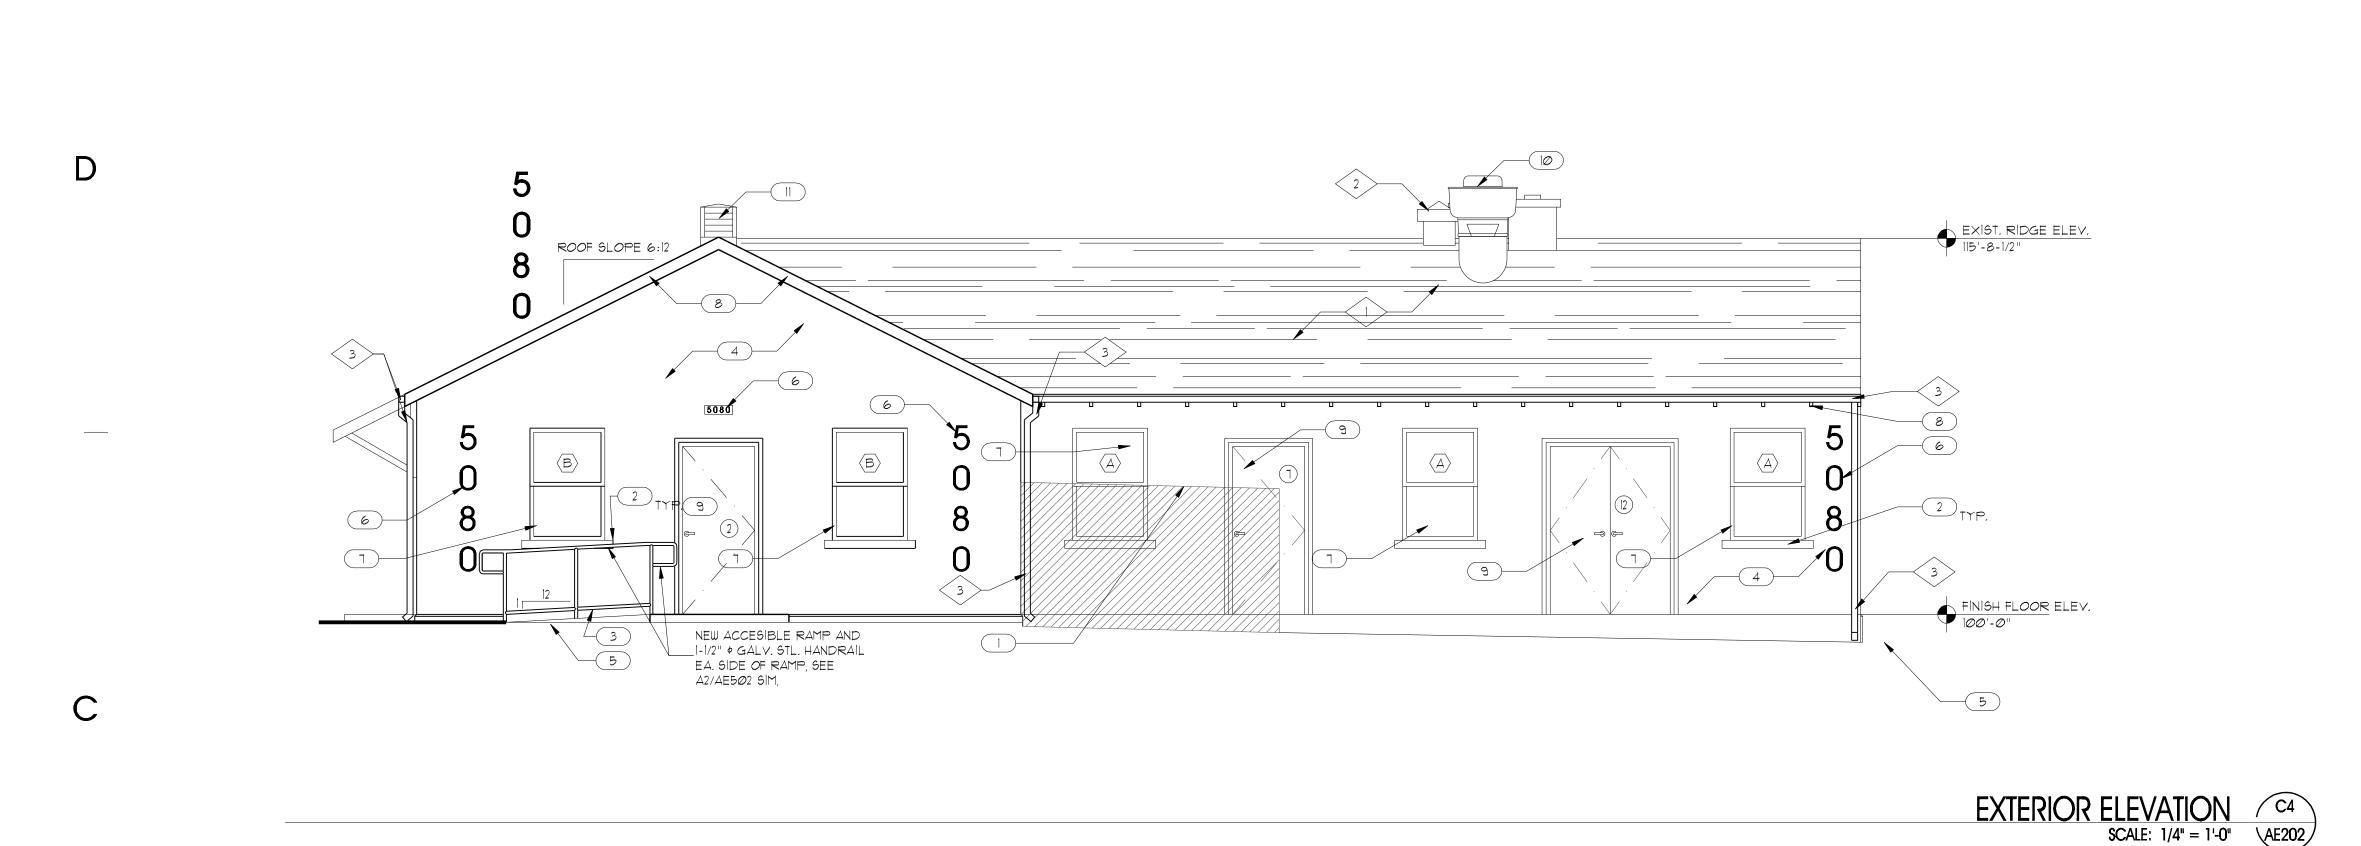

GENERAL NOTES AND LEGEND:

- SEE SHEET GIØØ2 FOR GENERAL NOTES.
- SEE COVER SHEET FOR DRAWING INDEX.
- DO NOT SCALE DRAWINGS.
- CONTRACTOR SHALL VERIFY ALL DIMENSIONS AND CONDITIONS BEFORE BEGINNING WORK AND SHALL REPORT TO THE ARCHITECT ANY ERRORS, INCONSISTENCIES OR OMISSIONS BEFORE BEGINNING WORK. SEE GENERAL NOTES AND SPECIFICATIONS.

ajc architects

ARCHITECT

PROJECT # 0781

703 east 1700 south salt lake city, utah 84105 ph: 801.466.8818 fx: 801.466.4411 ajc@ajcarchitects.com

EXISTING KEYED NOTE LEGEND:

- EXISTING ROOF STRUCTURE, SHEATHING & SHINGLES TO REMAIN. PROTECT DURING ALL PHASES OF DEMOLITION AND CONSTRUCTION. PATCH & REPAIR ALL EXIST. ROOF PENETRATIONS / HOLES LEFT FROM REMOVAL OF ROOF TOP VENTS & MECHANICAL EQUIPMENT.
- 2 EXISTING VENT TO REMAIN. PROTECT DURING ALL PHASES OF DEMOLITION AND CONSTRUCTION.
- 3 EXISTING GUTTER AND DOWNSPOUTS TO REMAIN PROTECT DURING ALL PHASES OF DEMOLITION AND CONSTRUCTION.

NEW KEYED NOTE LEGEND:

- 1) LINE OF NEW 6'-0" HIGH CHAIN LINK FENCE WITH VINYL INSERTS. COLOR OF INSERTS TO MATCH BUILDING. GENERAL CONTRACTOR TO SUBMIT SAMPLES TO ARCHITECT FOR REVIEW. ALL FENCE AND GATE DETAILS TO BE BY MANUFACTURER. PROVIDE LOCKING
- 2 PATCH AND PAINT EXISTING STUCCO SILLS.
- 3 NEW CONCRETE ADA RAMP & LANDING. SLOPE TO BE 1:12 SLOPE OR LESS. VERIFY EXISTING SITE SLOPE.
- 4 PREP. AND PAINT EXISTING BUILDING AND FOUNDATION WALLS TO MATCH EXISTING COLOR. G.C. TO PATCH & REPAIR ALL CRACKS, DELAMINATED AREAS AND OTHER DAMAGED AREAS PRIOR TO PAINTING. FIELD VERIFY PRIOR TO BIDDING.
- 5 LINE OF FINISHED GRADE.
- (6) REPAINT BUILDING NUMBERS. ADD "0" TO EACH NUMBER TO READ AS FOLLOWS: 508 TO 5080, AND 510 TO 5100. NEW NUMBER SIZE AND COLOR TO MATCH EXISTING.
- NEW WINDOW IN EXISTING MASONRY OPENING. HISTORIC RENOVATION STEEL WINDOWS @ BUILDING 5080. SEE WINDOW SCHEDULE SHEET.
- 8 PREP. AND PAINT EXISTING WOOD FASCIA & FRAMING MEMBERS.
- ${f 9}$ NEW DOOR AND FRAME IN EXISTING MASONRY OPENING. SEE DOOR SCHEDULE SHEET.
- LOCATION OF NEW EXHAUST FAN. USE SAME LOCATION OF ROOF PENETRATION AS PREVIOUS VENT IF POSSIBLE. SEE MECHANICAL DRAWINGS.

EXTERIOR ELEVATION

SCALE: 1/4" = 1'-0" \AE201

II LOCATION OF NEW COMBUSTION AIR PENTHOUSE. SEE MECHANICAL DRAWINGS. SEE A3/AE502 FOR CURB DETAIL.

PROJECT DESCRIPTION

State of Utah Department of Administrative Services



Division of Facilities Construction & Management 4110 State Office Building Salt Lake City, Utah 84114
Phone: (801) 538 - 3018 Fax: (801) 538 - 3267

Internet: http://www.dfcm.utah.gov

CAMP WILLIAMS BUILDINGS 5080 AND 5100

SD5 NEW ACCESIBLE RAMF AND 1-1/2" & GALV. __STL. HANDRAIL EA. SIDE *o*f RAMP, SEE A2/AE5Ø2 SIM, FINISH FLOOR ELE 1-1/2" ¢ GALV. STL. HANDRAIL —EA. SIDE *o*f RAMP, SEE 1-1/2" ¢ GALV. STL. HANDRAIL EA. SIDE OF STAIRS, SEE Α A2/AE5**Ø**2, B1/AE502,

SHEET NAME:

EXTERIOR ELEVATIONS

SD2

REVISIONS

DATE DESCRIPTION

MAY 2008

CDS


issue data


ISSUE DATE:


BJR KRR CHECKED BY: CAD FILE NAME: AE


DFCM PROJECT # 07332480 CONTRACT # 087184 COPYRIGHT: DFCM


SHEET NUMBER:

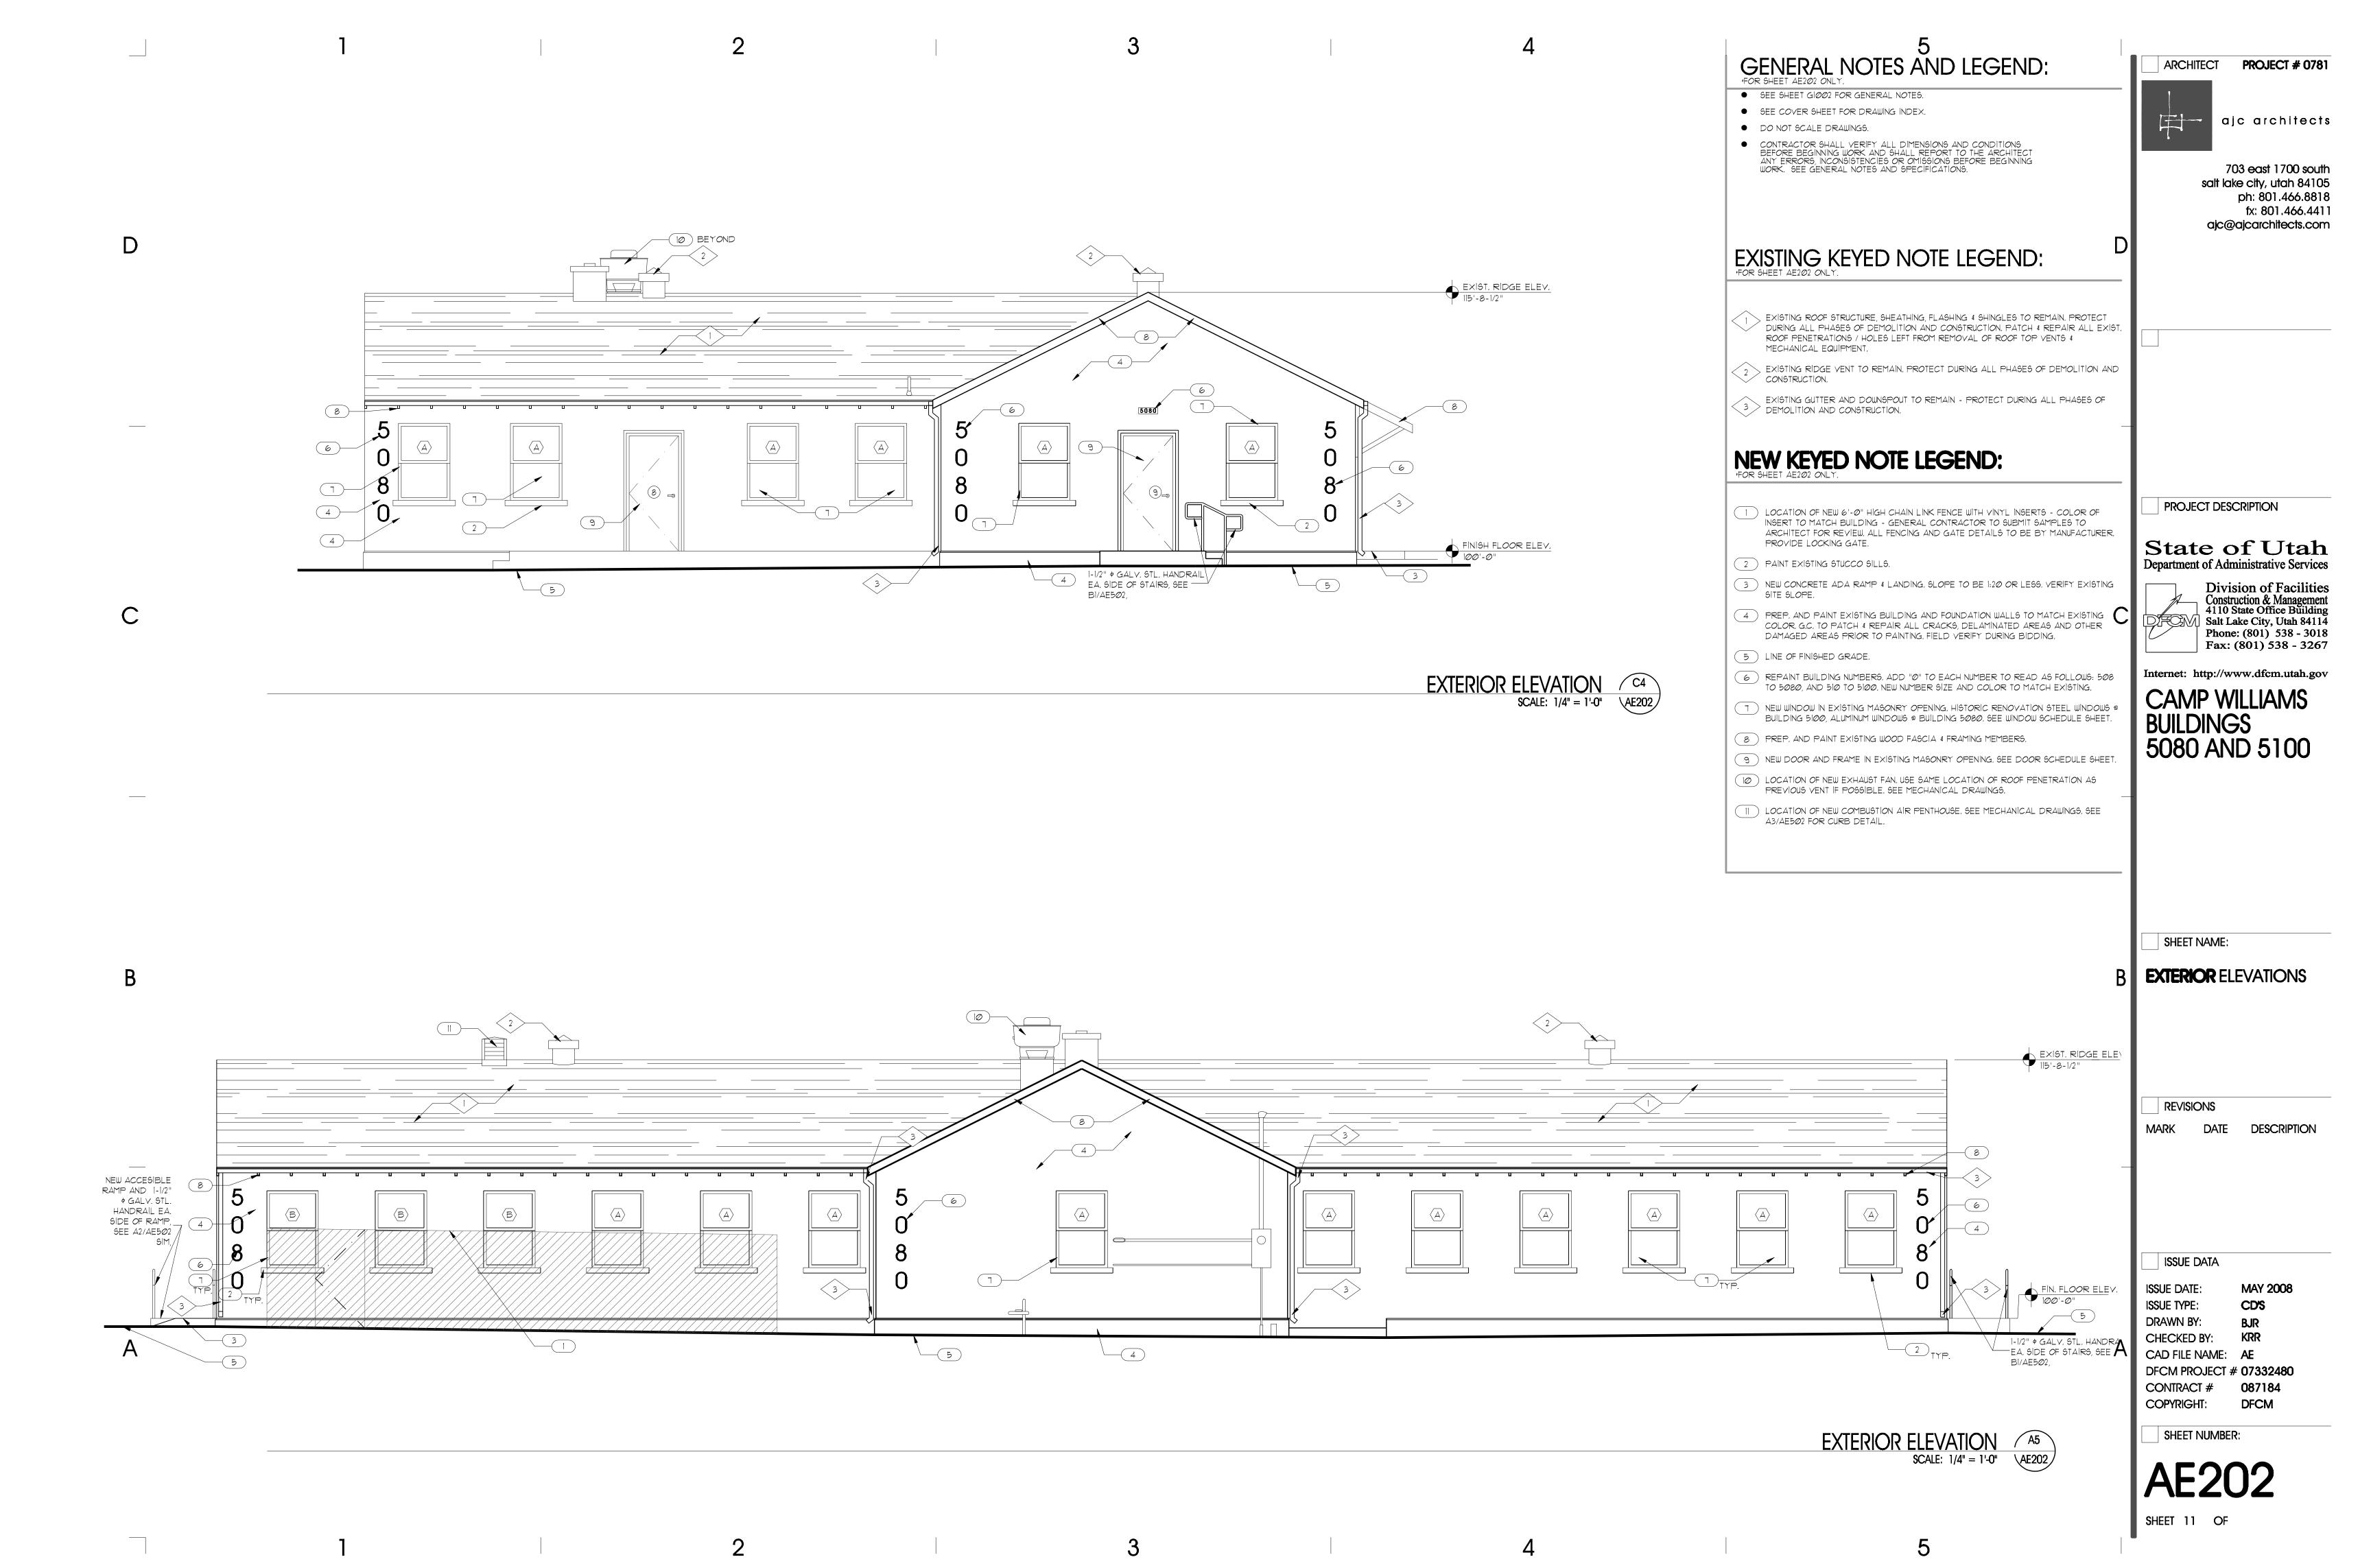

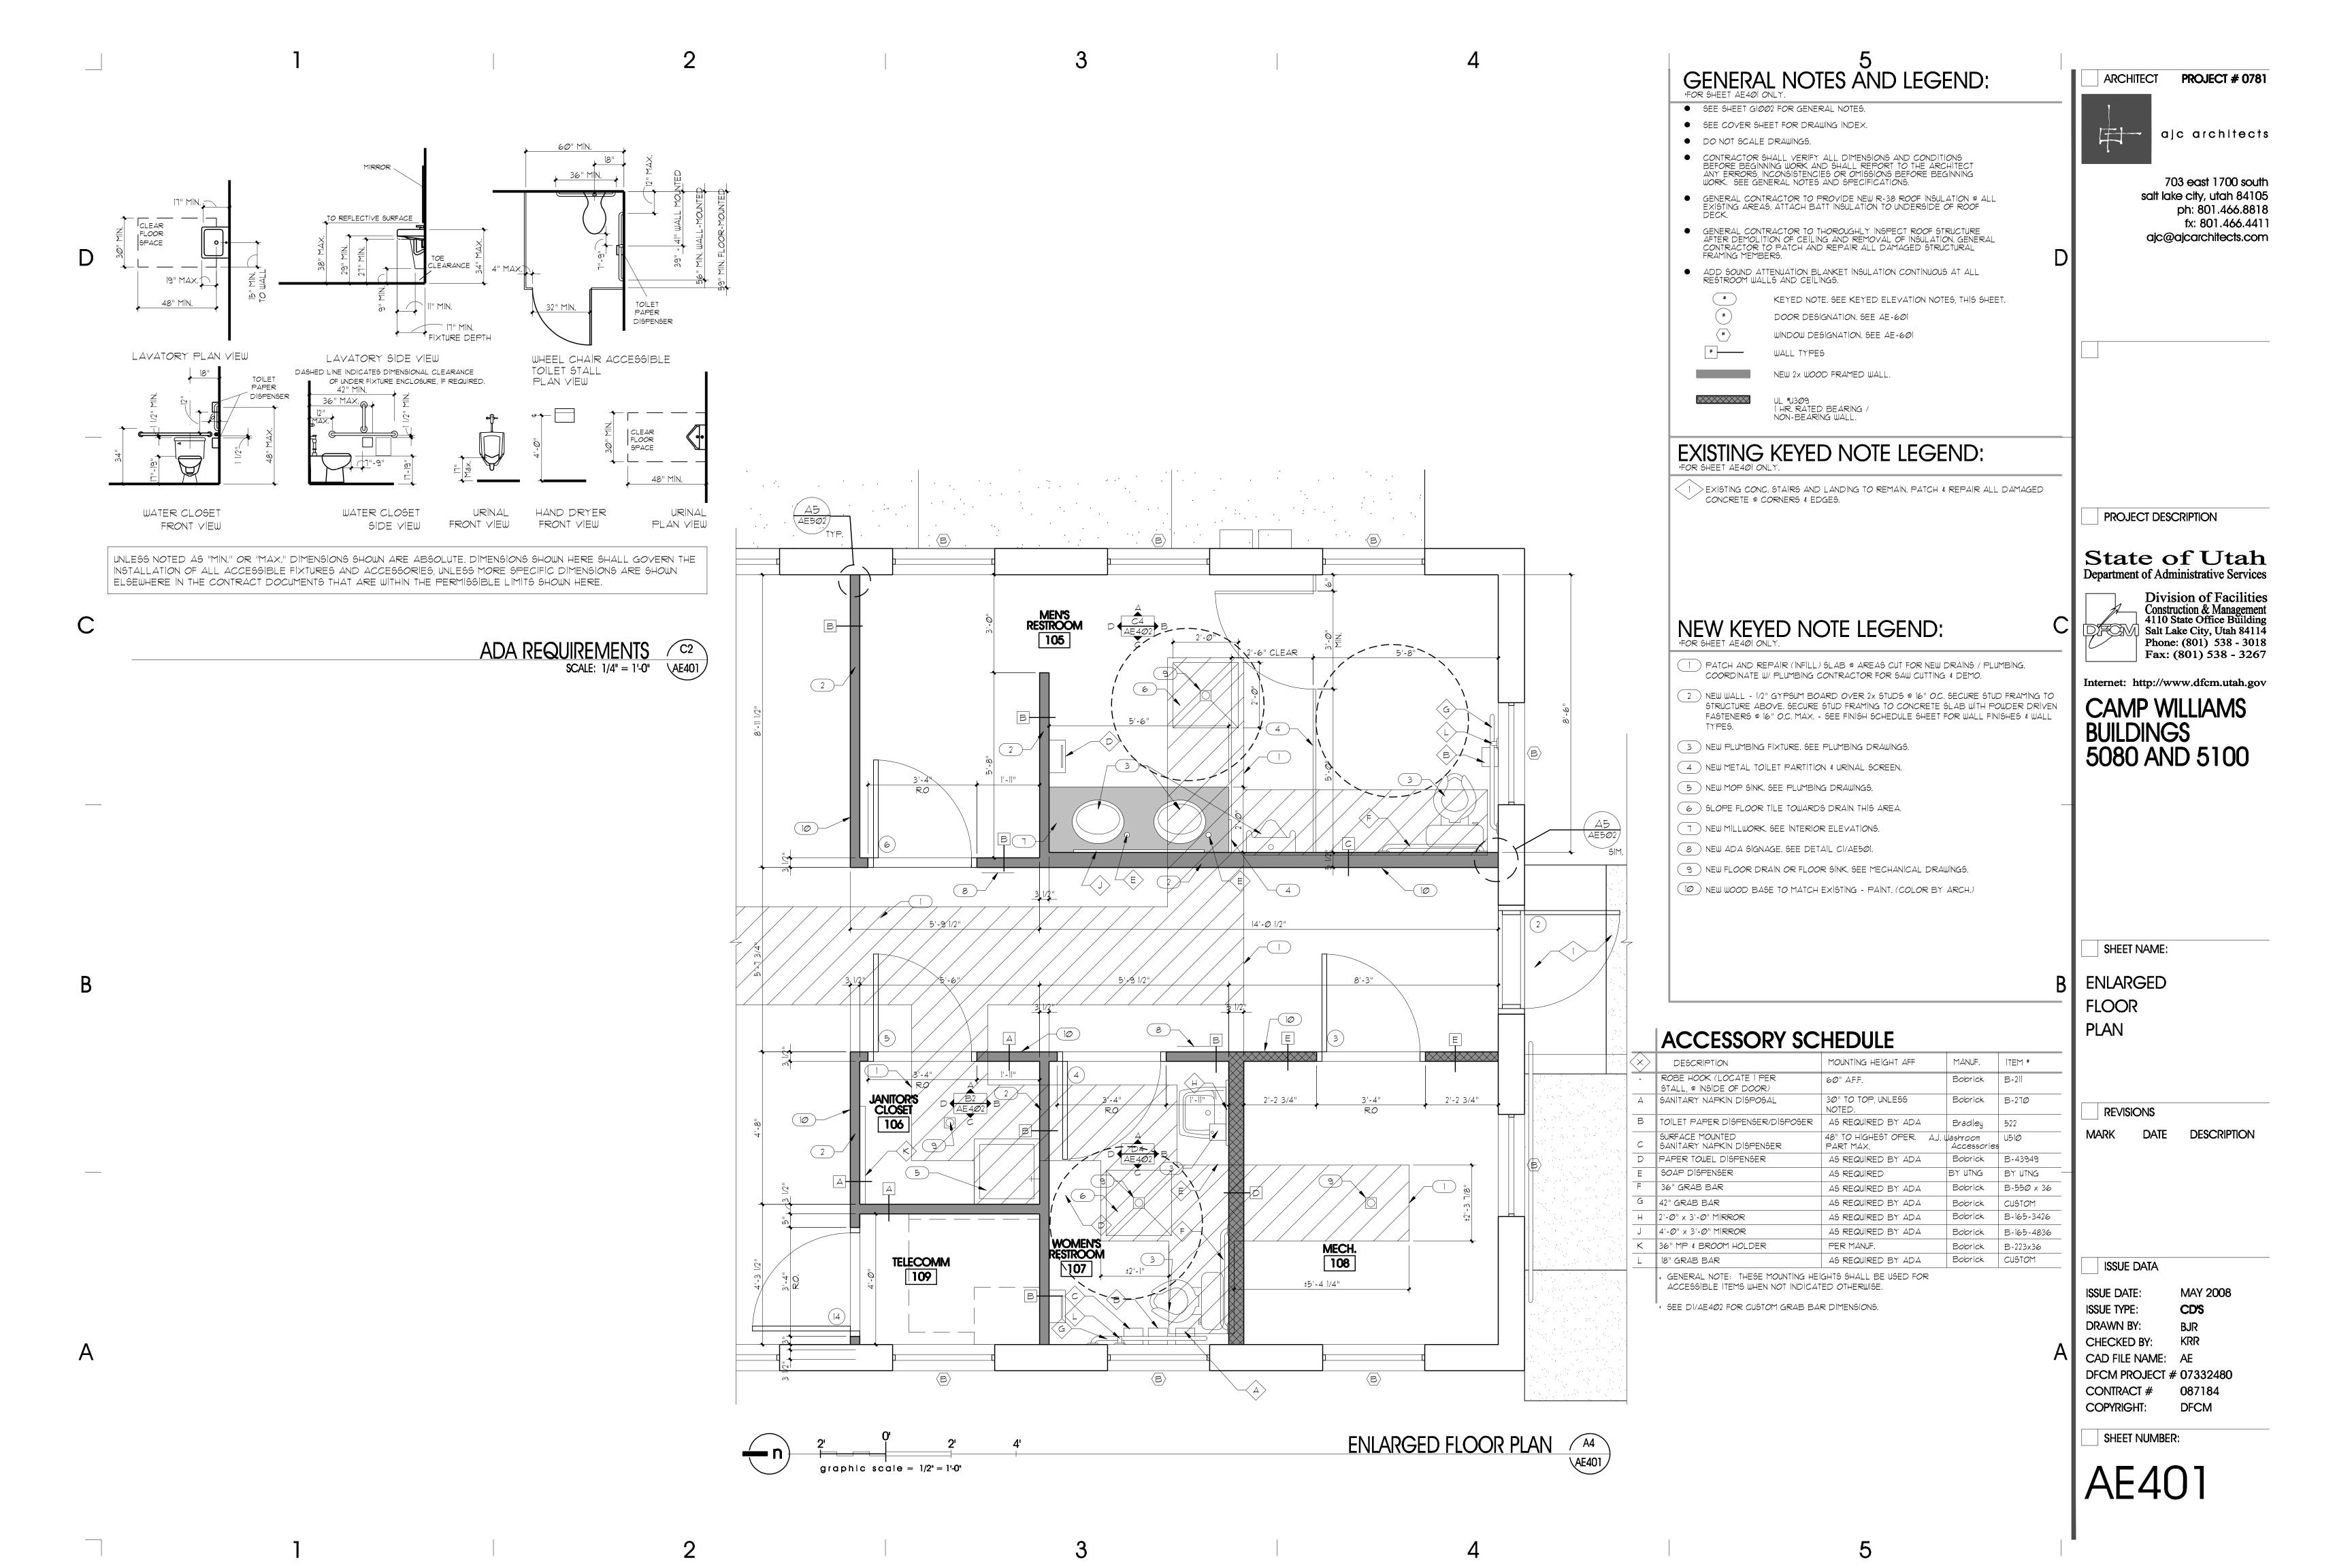

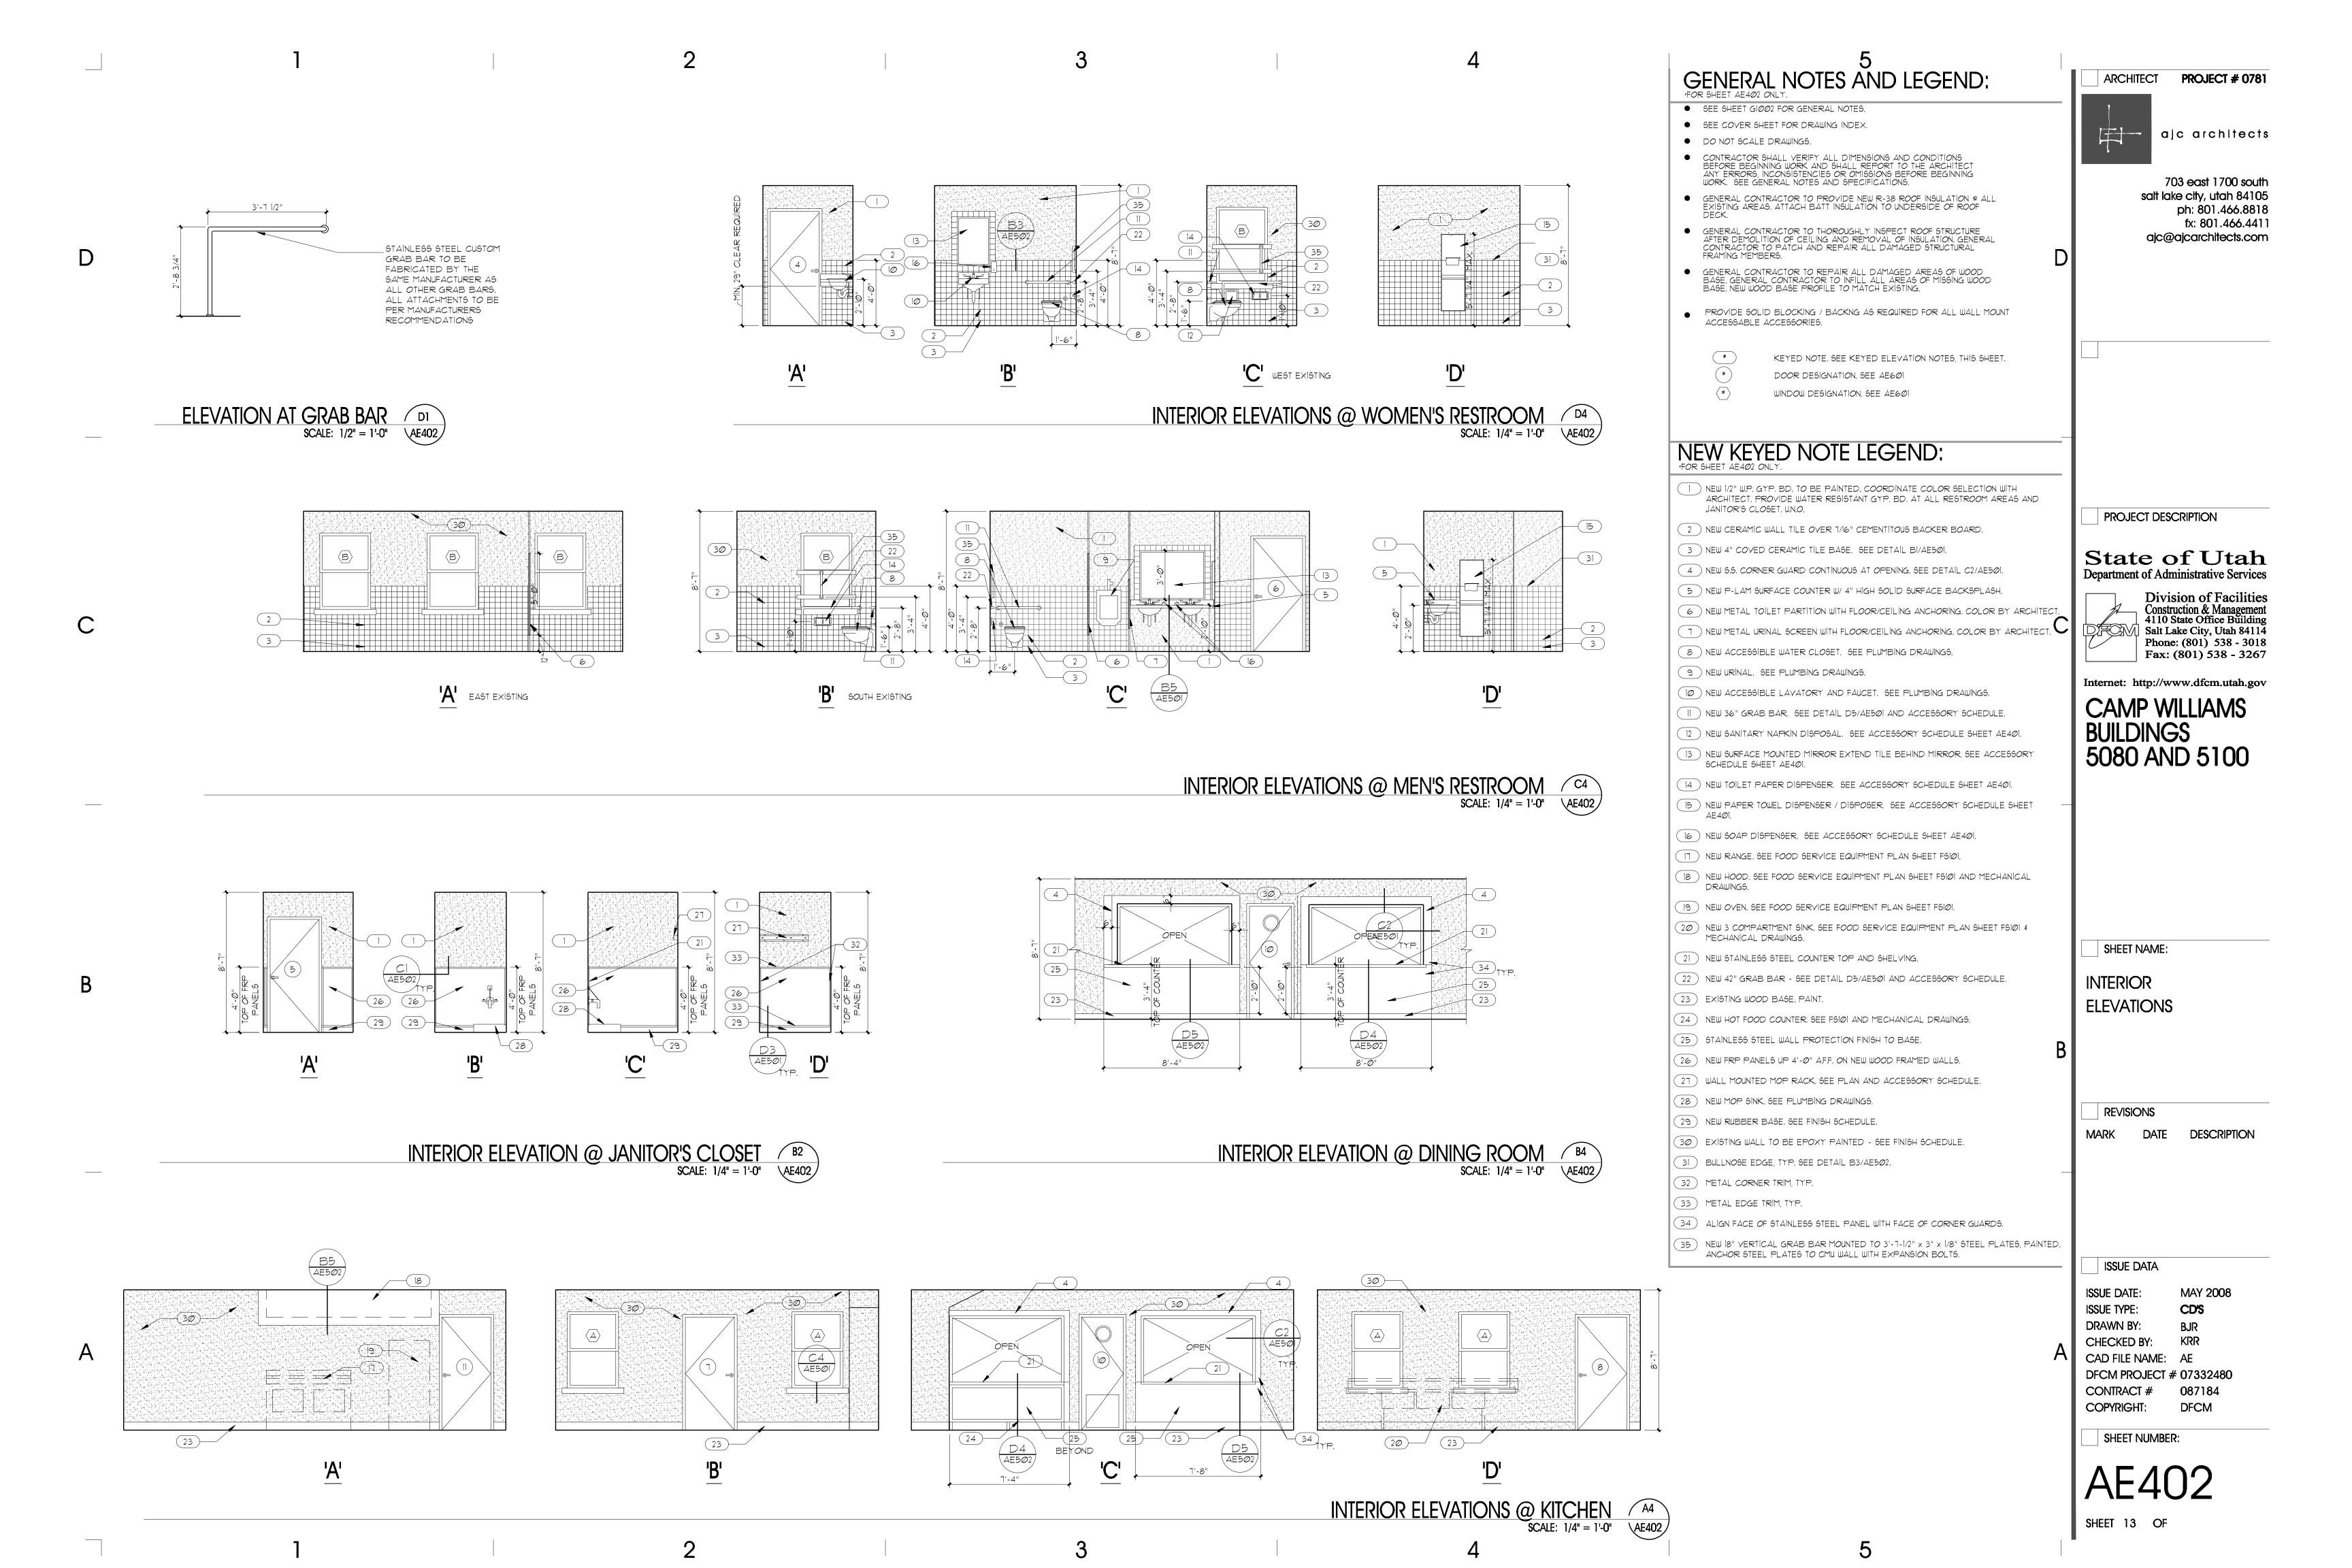


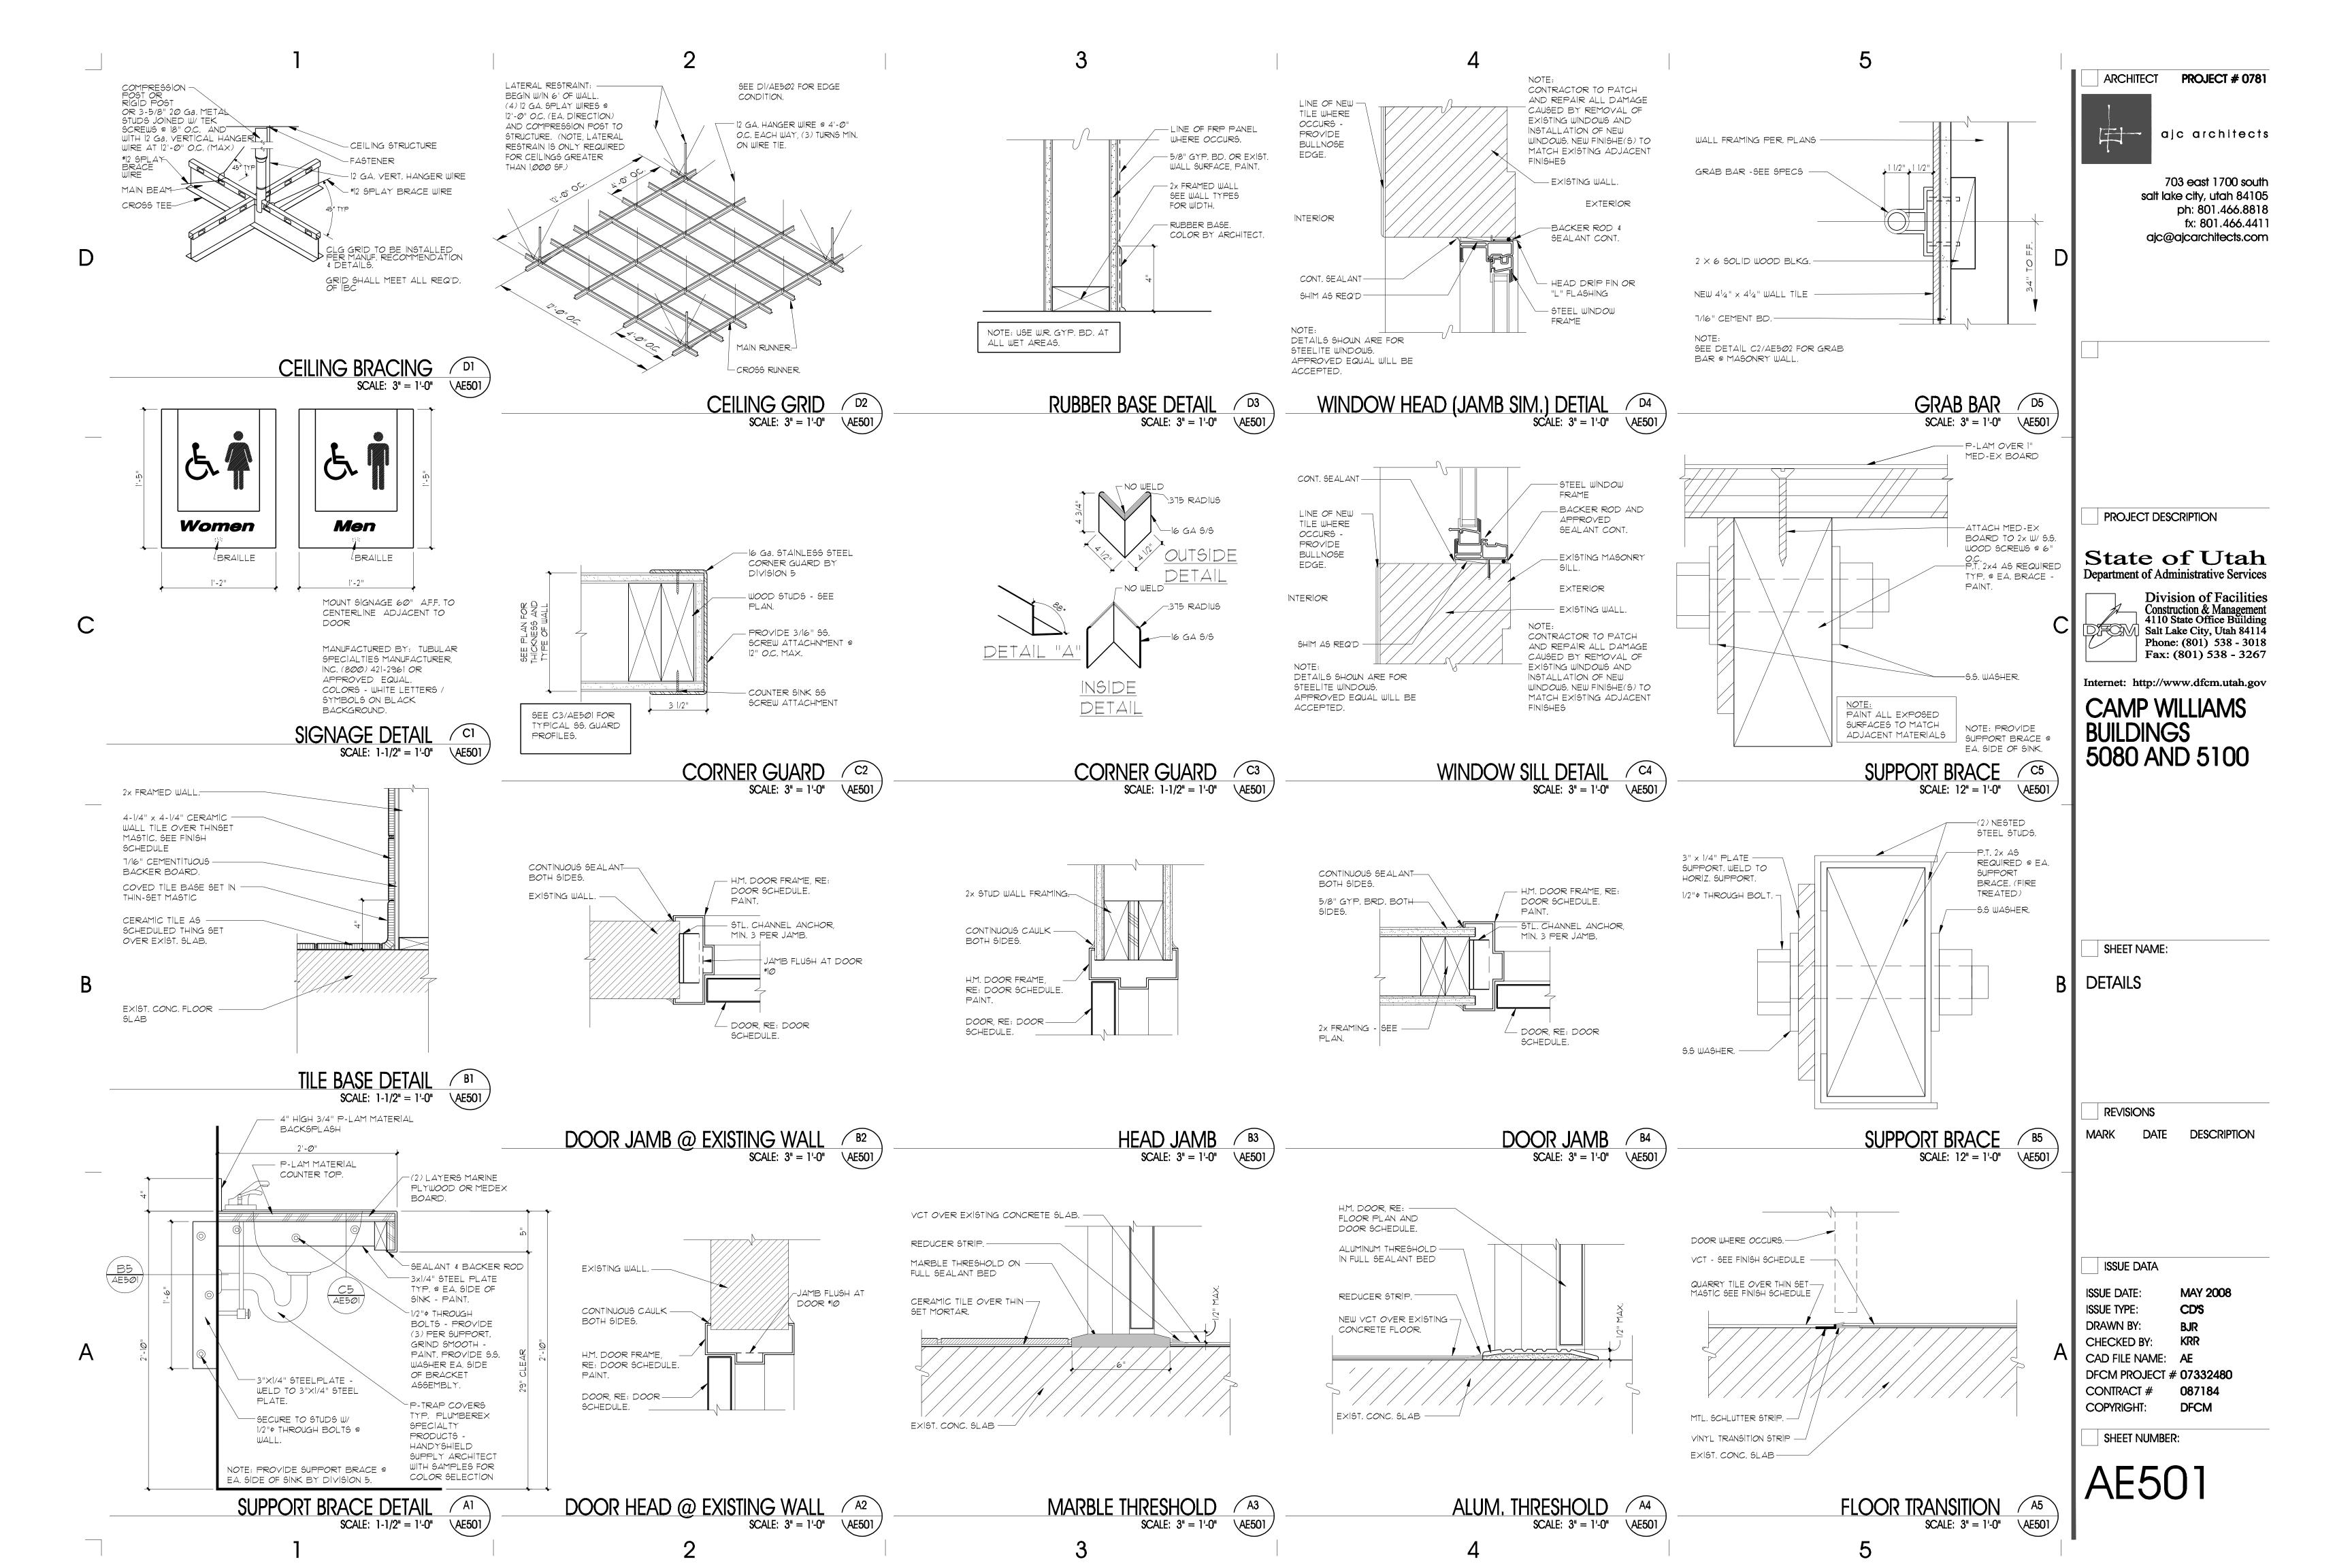

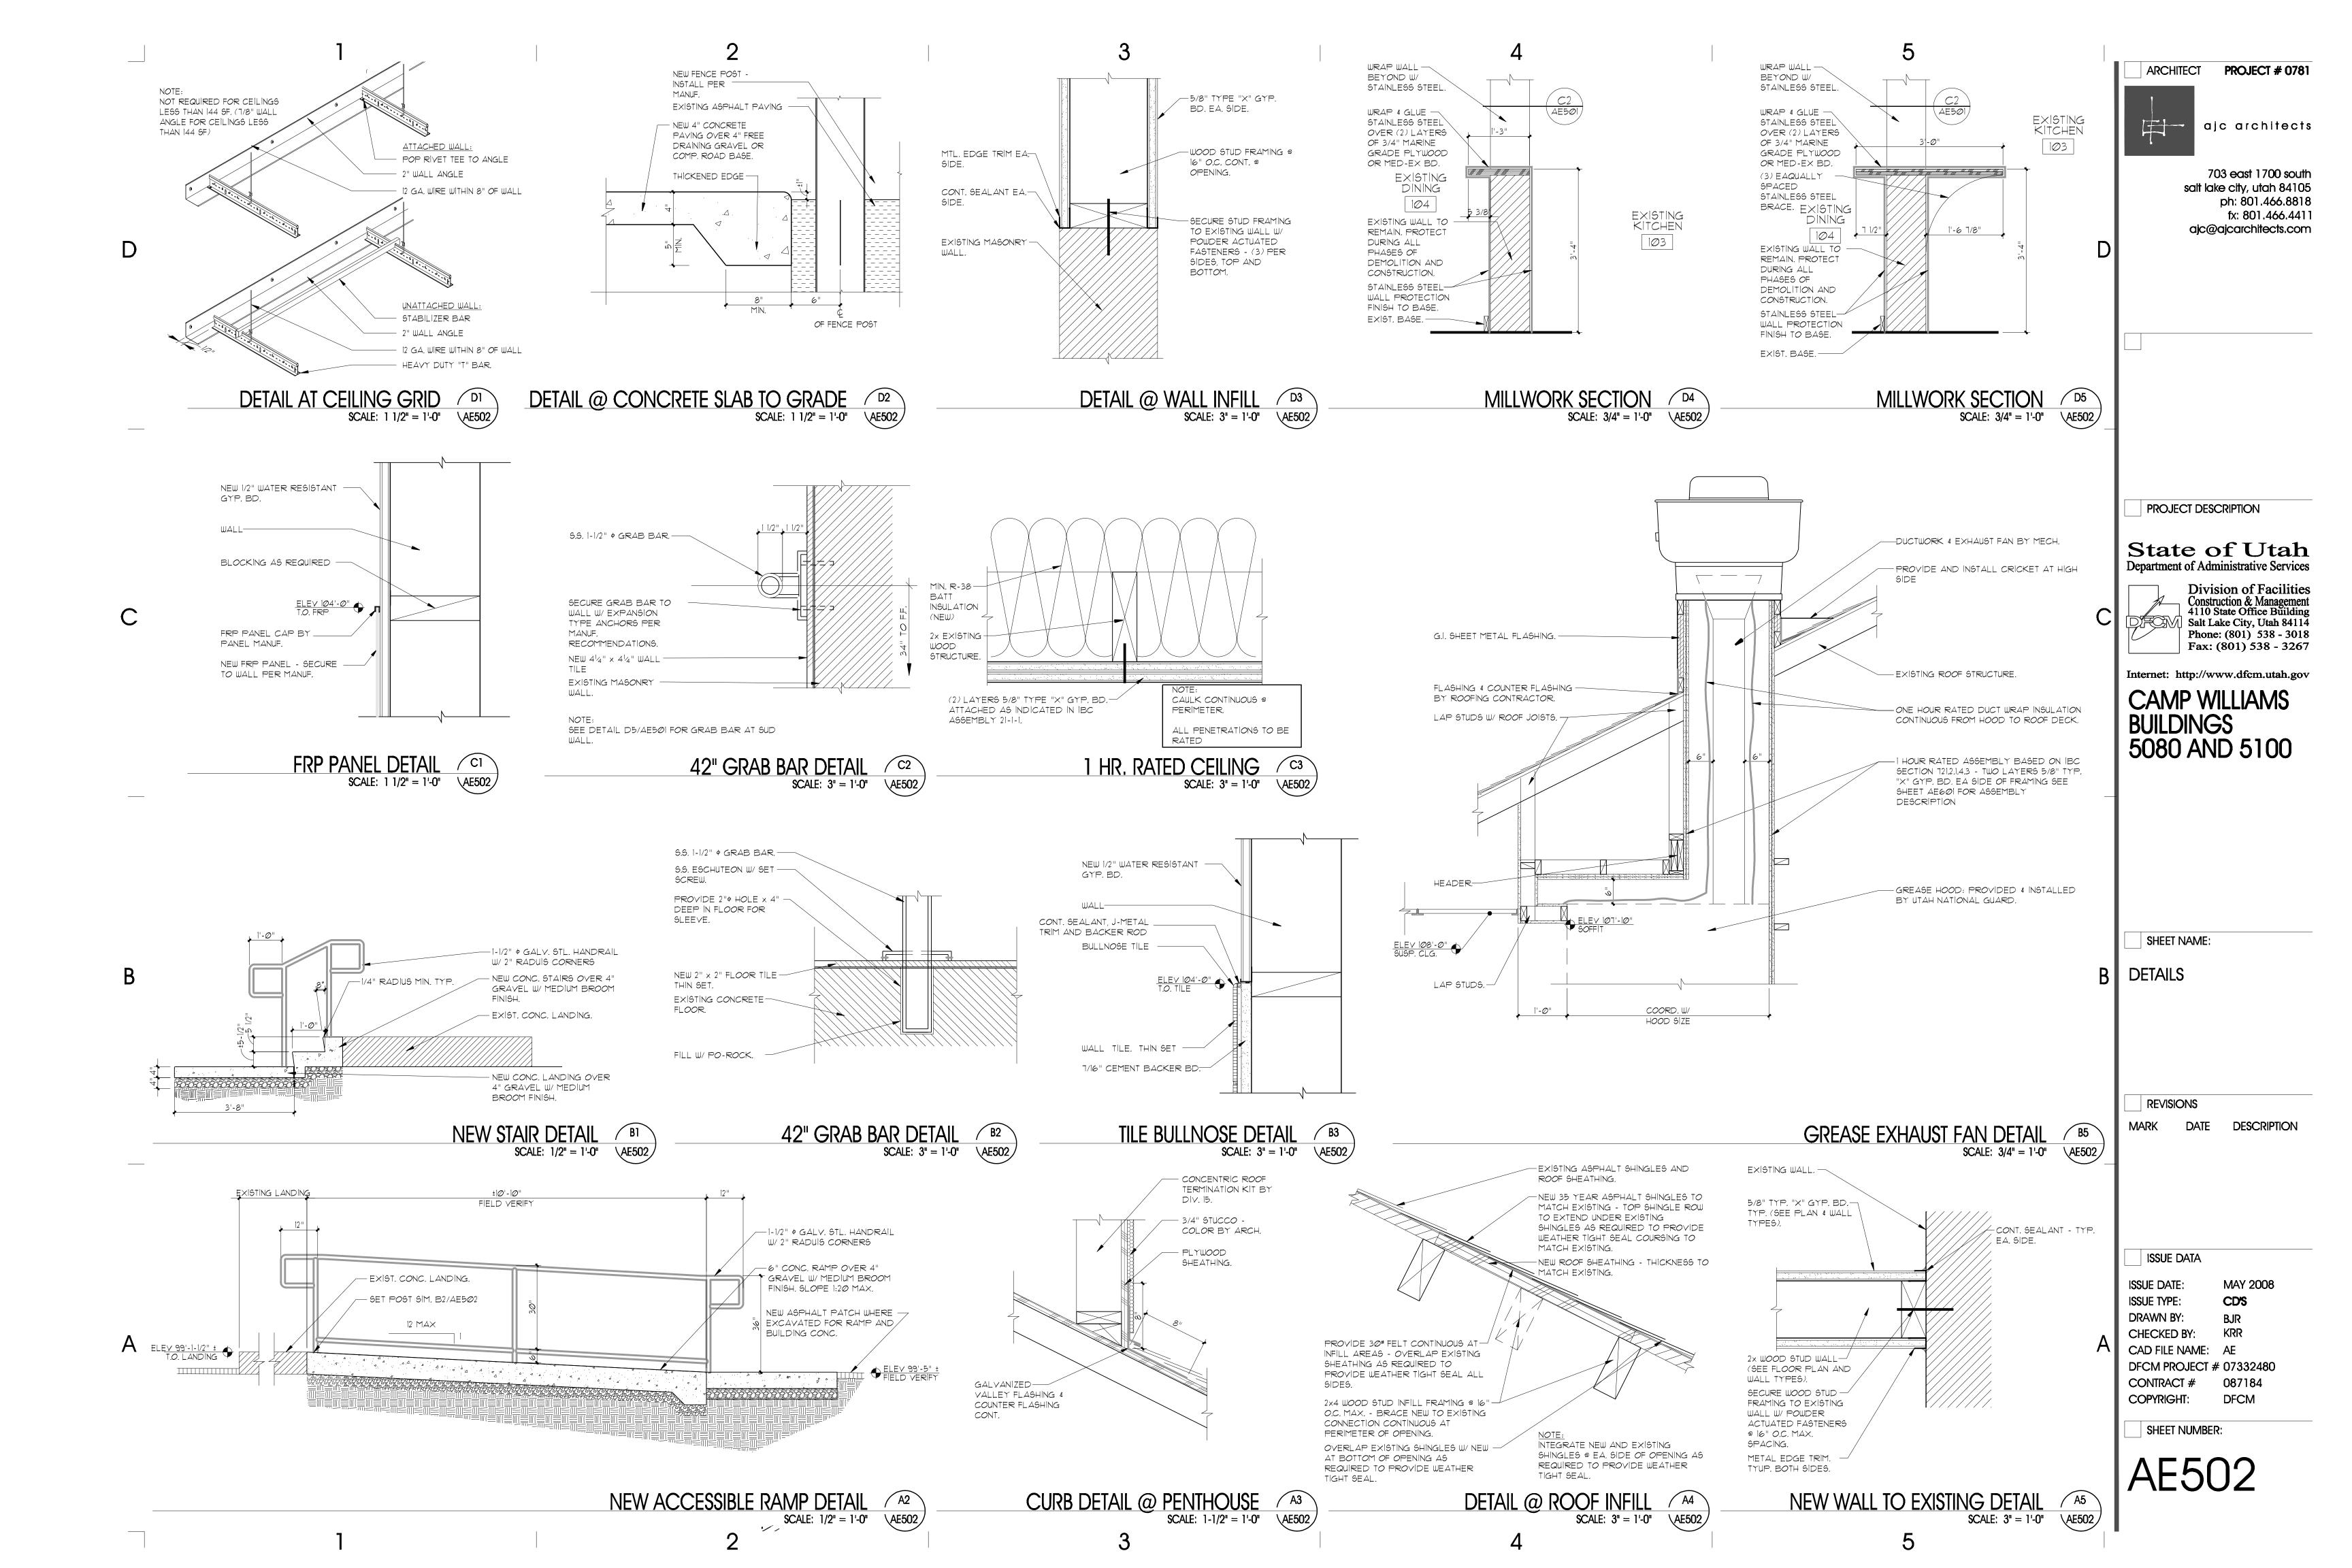

		ROOM FINISH S		HE	Dl	JLĮ													2							
-	RM NO.	ROOM NAME E	BASE 			-	FLO	ORING			WALI	L NOR	RTH	WAL	L EAS	5T	WAL	L 50U	TH	WAL	L WES ⁻	Ť	CEI	_ING		
		EXION N	\wedge $ $ $/$		RUBBER BASE	(E) WOOD BASE	Q QUARRY TILE	CERAMIC FLOOR TILE	\\\\\\\\\\\\\\\\\\\\\\\\\\\\\\\\\\\\\\	SEALED CONC.	CERAMIC WALL	GYP. BD JU PAINT-PI	GYP. BD CAYD-PS CB-ZNI-PS	CERAMIC WALL	GYP. BD dd PAINT-PI	GYP. BD GYP. BD DAINT-P2	CERAMIC WALL	GYP. BD DAINT-PI	GYP. BD CAPINT-P2	CERAMIC WALL	GYP. BD A PAINT. PI	GYP. BD CA PAINT. P2	ACOUSTICAL TILE, STYLE-ATI	ACOUSTICAL THE STYLE AT	HR RATED GYP. BD. CEIL.	>
		MAIN LEVEL		<i>7</i> 1`		<u> </u>																				
	102	EXISTING STORAGE																								
) _	103	EXISTING STORAGE																								
	104	EXISTING KITCHEN																	•							
	105	EXISTING DINING																								
	106	MEN'S RESTROOM												•			•									
	107	JANITOR'S CLOSET																								
	108	WOMEN'S RESTROOM															•		•							
_	109	MECHANICAL																						•		
									-				1		-	1		1			1	1			1	,
	1-	PROVIDE FRP PANELS TO HEIGHT OF AS SHOWN ON INTERIOR ELEVATION	OF 4'-0			WET (WALL S	3 AND	_																	
	2 -	CERAMIC WALL TILE (CTW) SHALL E PAINT WALL FROM TOP OF TILE TO				Y PA	init t	YPE P.	າ																	
	3-	GYPSUM BOARD TO BE WATER RES							٤.																	
	<i>5</i> - 4-	ALL RESTROOMS TO RECEIVE EPOX			UVE C	-LINAI	no II																			
	5-	ALL COLORS TO BE SELECTED BY			Ť																					
	-	ALL FLOOR TILE TO BE SLIP RESIS		11120	1,																					
	6-	ALL FLOOR TILE TO BE 9LTF RE919	JI AINI.																							
		INTERIOR FINISH LEGEND																								
	SYMBOL	FINISH		NOTE								•														
-		FLOOR		_								-														
_	QT>	QUARRY TILE -2,(6"x6")		4	ONE C	COLO	₹					-														
	CFT	CERAMIC FLOOR TILE -1, (2"x2")			CERA DAL 1			TILE NSTONE	RANGI	E D15	6															
_				4	10 > 4 10							-														
	<u>vct</u>	VINYL COMPOSITION TILE			12 × 12 4/A2.2		.2, 12/4	42.2				-														
	(EC)	EXPOSED CONCRETE. SEALED			SEE S	PEC.																				
_		BASE		_																						
_	EX	EXISTING, PROTECT CERAMIC TILE BASE -1, (4"x4") W/		4	PAINT	P-5	AS SE	ELECTE	D BY A	ARCH	HITECT	-														
_	(CTB)	SANITARY COVE		4	COLO	R BY	ARCI	HITECT				-														
_	RBI	RUBBER BASE		4	COLO	R BY	ARCI	HITECT				-														
	WBI	WOOD BASE - PROFILE TO MATCH EX	XISTING	i	COLO	R BY	ARCI	HITECT																		
3																										
J		WALLS																								
-	(CTW)	CERAMIC WALL TILE -I, (4"x4")	1	Т	CERA	MIC "	- بالا	rlı =				•														
	~	TILE WAINSCOT TO BE 4'-8" AFF. WITH GP-1 EPOXY PAINT ABOVE TILE.	7		DAL 1																					
_	(GPI)	GYP9UM BOARD, PAINTED -PI			INDIC,	RSCO ATES		MBOL KY PAIN	۱T.			-														
_	GP2	GYP9UM BOARD, PAINTED -P2 EPOX ACOUSTICAL WALL PANELS	(Y PAIN	NT		RSC0		MBOL																		
_	•				inDIC,	4TES	±PO>	KY PAIN	NI.																	
_	·			_	WHITE	GRID)					•														
_	ΔΤΙ	ACQUISTICAL THE-LLAY-IN (2'x4')		- 1		G1 11B						-														
	ATI)	ACOUSTICAL TILE-I, LAY-IN, (2'x4')		+	WHITE	GRIN	YNY (L SURF	ACF																	
	<u>AT1</u> <u>AT2</u>	ACOUSTICAL TILE-1, LAY-IN, (2'x4') ACOUSTICAL TILE-2, LAY-IN, (2'x4')		+	WHITE	GRID	YNY	'L SURF	ACE			-														
	AT2>	ACOUSTICAL TILE-1, LAY-IN, (2'x4') ACOUSTICAL TILE-2, LAY-IN, (2'x4') OTHER		† -						TECT																
	AT2	ACOUSTICAL TILE-I, LAY-IN, (2'x4') ACOUSTICAL TILE-2, LAY-IN, (2'x4') OTHER INTERIOR LATEX PAINT		 	SEE S	PEC.	COLC	PR BY A	ARCHIT			-														
-	AT2	ACOUSTICAL TILE-1, LAY-IN, (2'x4') ACOUSTICAL TILE-2, LAY-IN, (2'x4') OTHER	LS	1	SEE S	PEC.	COLO	PRBY A	ARCHIT ARCHIT	TECT	TINE	-														
	PI P2 P3	ACOUSTICAL TILE-I, LAY-IN, (2'x4') ACOUSTICAL TILE-2, LAY-IN, (2'x4') OTHER INTERIOR LATEX PAINT INTERIOR EPOXY PAINT	L9	 	SEE S	PEC.	COLO	DR BY A	ARCHIT ARCHIT	EXIS		-														
	P1 P2 P3 P4	ACOUSTICAL TILE-I, LAY-IN, (2'x4') ACOUSTICAL TILE-2, LAY-IN, (2'x4') OTHER INTERIOR LATEX PAINT INTERIOR EPOXY PAINT EXTERIOR LATEX PAINT AT ALL WALL AND FOUNDATIONS EXTERIOR LATEX PAINT FOR BUILDING NUMBERS INTERIOR LATEX PAINT FOR WOOD TR	RIM,		SEE S SEE S	PEC. PEC.	COLC COLC COLC	DR BY ADR TO M	ARCHIT ARCHIT 1ATCH 1ATCH	EXIS		-														
	PI P2 P3	ACOUSTICAL TILE-I, LAY-IN, (2'x4') ACOUSTICAL TILE-2, LAY-IN, (2'x4') OTHER INTERIOR LATEX PAINT INTERIOR EPOXY PAINT EXTERIOR LATEX PAINT AT ALL WALL AND FOUNDATIONS EXTERIOR LATEX PAINT FOR BUILDING NUMBERS	RIM,		SEE S SEE S	PEC. PEC.	COLC COLC COLC	DR BY A	ARCHIT ARCHIT 1ATCH 1ATCH	EXIS		-														

QTY	ITEM	ARE SCHED	FINISH	MANUFACTURER	
QTT	GROUP		FINIOH	TIANGI ACTURLIN	
IF DAID			120	DOMMED	
1.5 PAIR 1 EA.	BUTTS	98L x IC BEST CYL	26D 26D	BOMMER VON DUPRIN	
1 EA.	CLOSER	P4Ø41 SPRING CUSH	-	LCN	
1 E.A.	KICK PLATE	10" x2" LDW	32D	QUALITY	
1 EA.	THRESHOLD	425	1 -	NG	
1 E.A.	WEATHER-STRIP	160	-	NG	
1 E.A.	SWEEP	200	-	NG	
	GROUP	2			
5 PAIR	BUTTS	BB5002 4.5 x 4.5	26D	BOMMER	
1 E.A.	LOCK SET	93K1 X IC BEST CYL	626	BEST	
1 E.A.	CL09ER	P4Ø41 SPRING CUSH	ļ.	LCN	
1 EA.	KICK PLATE	10" x 2" LDW	32D	QUALITY	
1 E.A.	THRESHOLD	425	-	NG NG	
1 EA. 1 EA.	WEATHER-STRIP SWEEP	160	1.	NG NG	
, <u>, , , , , , , , , , , , , , , , , , </u>	GROUP	_	I		
E DAID			245	OHALITY	
1.5 PAIR 1 E.A.	BUTTS LOCK SET	93K1 AB 15C	26D 626	QUALITY BEST	
1 EA.	STOP	302	26D	QUALITY	
. =	GROUP	_	1	1	
1.5 PAIR	BUTTS	BB500 4.5 x 4.5	26D	QUALITY	
1 EA.	LOCK SET	93K1 D 15C	26D 26D	BEST	
2 EA.	FLUSH BOLT	1358 12"	26D	QUALITY	
2 EA.	CLOSER	P4Ø41 EDA H	-	LNC	
2 EA.	STOP	3Ø7	26D	QUALITY	
1 E.A.	THRESHOLD	425	-	NG	
1 E.A.	WEATHERSTRIP	160	ļ ·	NG	
1 E.A.	SWEEP	200	-	NG	
	GROUP	<u>5</u>			
1.5 PAIR	BUTTS	BB5 <i>000</i> 4.5 x 4.5	26D	BOMMER	
1 E.A.	PUSH	4Ø 3.5 xl5	26D	QUALITY	
1 E.A.	PULL	15100 3.5 x15	26D	QUALITY	
1 EA. 1 EA.	CLOSER KICK PLATE	4041 10" × 2" LDW	32D	LCN QUALITY	
1 E.A.	SWEEP	307	26D	QUALITY	
	GROUP	^ '	1	I	
1.5 PAIR	BUTTS	BB5000 4.5 x 4.5	26D	BOMMER	
1 E.A.	PRIVACY	93KØ L 15C	26D	BEST	
1 EA.	CLOSER	4041	1 -	LNC	
1 EA.	KICK PLATE	10" × 2" LDW	32D	QUALITY	
1 E.A.	STOP	3Ø2	26D	QUALITY	
	GROUP	7			
1.5 PAIR	BUTTS	BB5000 4.5 x 4.5	26D	BOMMER	
1 E.A.	LOCK SET	93K1 D 15C	26D	BE9T	
1 EA.	CLOSER	P4Ø41 EDA	-	LCN	
1 EA.	STOP	3Ø7	26D	QUALITY	
1 E.A.	SMOKE SEAL	2525	-	NG	
	GROUP	8			
3 PAIR	SPRING HINGE	3029-6	26D	BOMMER	
2 EA.	PUSH ADVISOR DI ATT	40 3.5 xl5	26D	QUALITY	
2 EA. 2 EA.	ARMOR PLATE STOP	40" x2" LDW 331 ED	32D 26D	QUALITY QUALITY	
∠ ⊑ <i>A.</i>				GUMEIII	
	GROUP	9			
	 	R DOOR #10 TO BE PROVIDE	ED BY MANUFAC	CTURER	
	1				

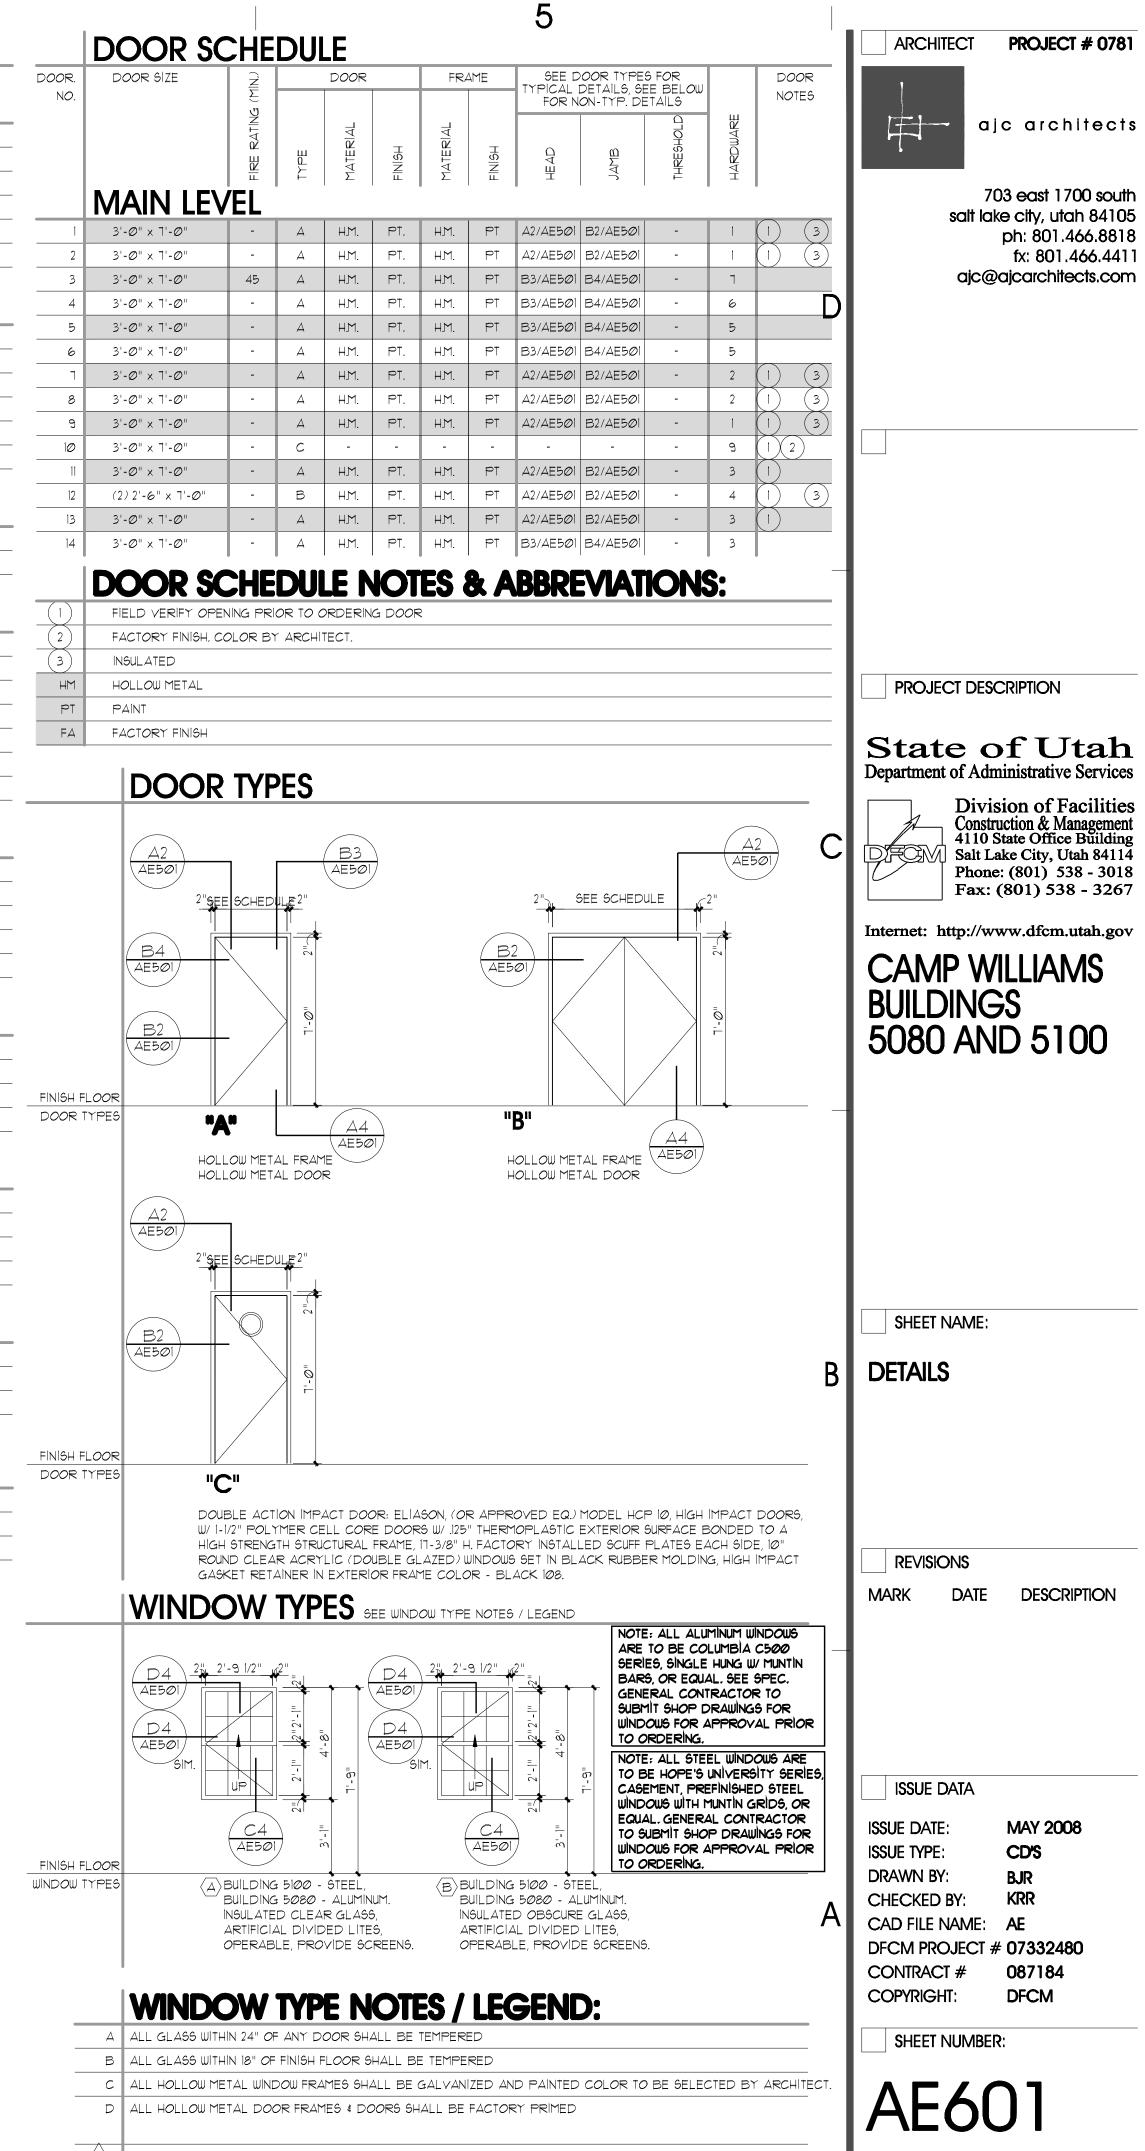

INDICATES TEMPERED GLAZING INDICATES DIRECTION OF SWING (POINT INDICATES HINGE LOCATION)

FOOD SERVICE SCHEDULE SIZE LOCATION ELECTRICAL PLUMBING GAS LINE REMARKS NAME MODEL NUMBER REQUIREMENTS REQUIREMENTS BOOSTER HEATER PER PLAN RANGE GRILLE GARLAND 62" W x 30" D x 44" H PER PLAN SNEEZE GUARDS HOT FOOD COUNTER EAGLE SWTS 240 PER PLAN CENTER DRAIN 79" W x 30" D x 35" H 24ØV BAYONNE 1100 COLD FOOD COUNTER PER PLAN 1/2" CW 3/4" DRAIN 33½" W × 73" D × 37½" S.S. OVEN / RANGE HOOD GAYLORD *GX2-BDL PER PLAN CONVECTION OVEN WOLF 62 AMPS 110V 50" W × 30" D × 66" H PER PLAN TRUE 22**Ø**V REFRIGERATOR 78" W × 36" D × 82" H PER PLAN TRUE 1100 FREEZER PER PLAN 78" W x 36" D x 82" H PER PLAN 1100 BREAD DISPENSER COFFEE POTS PER PLAN 1100 PER PLAN 1100 BEVERAGE DISPENSER 3 COMPARTMENT STAINLESS STEEL SINK PER PLAN DISPOSAL SINK 2 HP 110V GREASE TRAP **REMARKS** NEW CONVECTION OVEN TO BE COMPLETE WITH EXHAUST CANOPY (2) TO BE PROVIDED AND 3 G.C. TO VERIFY HEIGHT REQUIRED TO FIT GARBAGE DISPOSER \nearrow ducted to roof mounted exhaust fan. Duct to be installed $\stackrel{\checkmark}{\smile}$ installed by G.C. . UNDER (3) COMPARTMENT SINK AND PROVED LEG HEIGHT

EXTENSION AS / IF REQUIRED BY SINK ASSEMBLY.


ALL OF THIS EQUIPMENT IS PROVIDED & INSTALLED BY UTAH NATIONAL GUARD. U.N.O.

16 GA. STAINLESS STEEL. PLUMBING CONTRACTOR TO FURNISH 1"

GAS SUPPLY LINE TO OVENS WITH 3/4" GAS VALVES. CONTRACTOR TO FURNISH AND INSTALL OVEN EXHAUST HOOD OVER OVENS.

В

Α

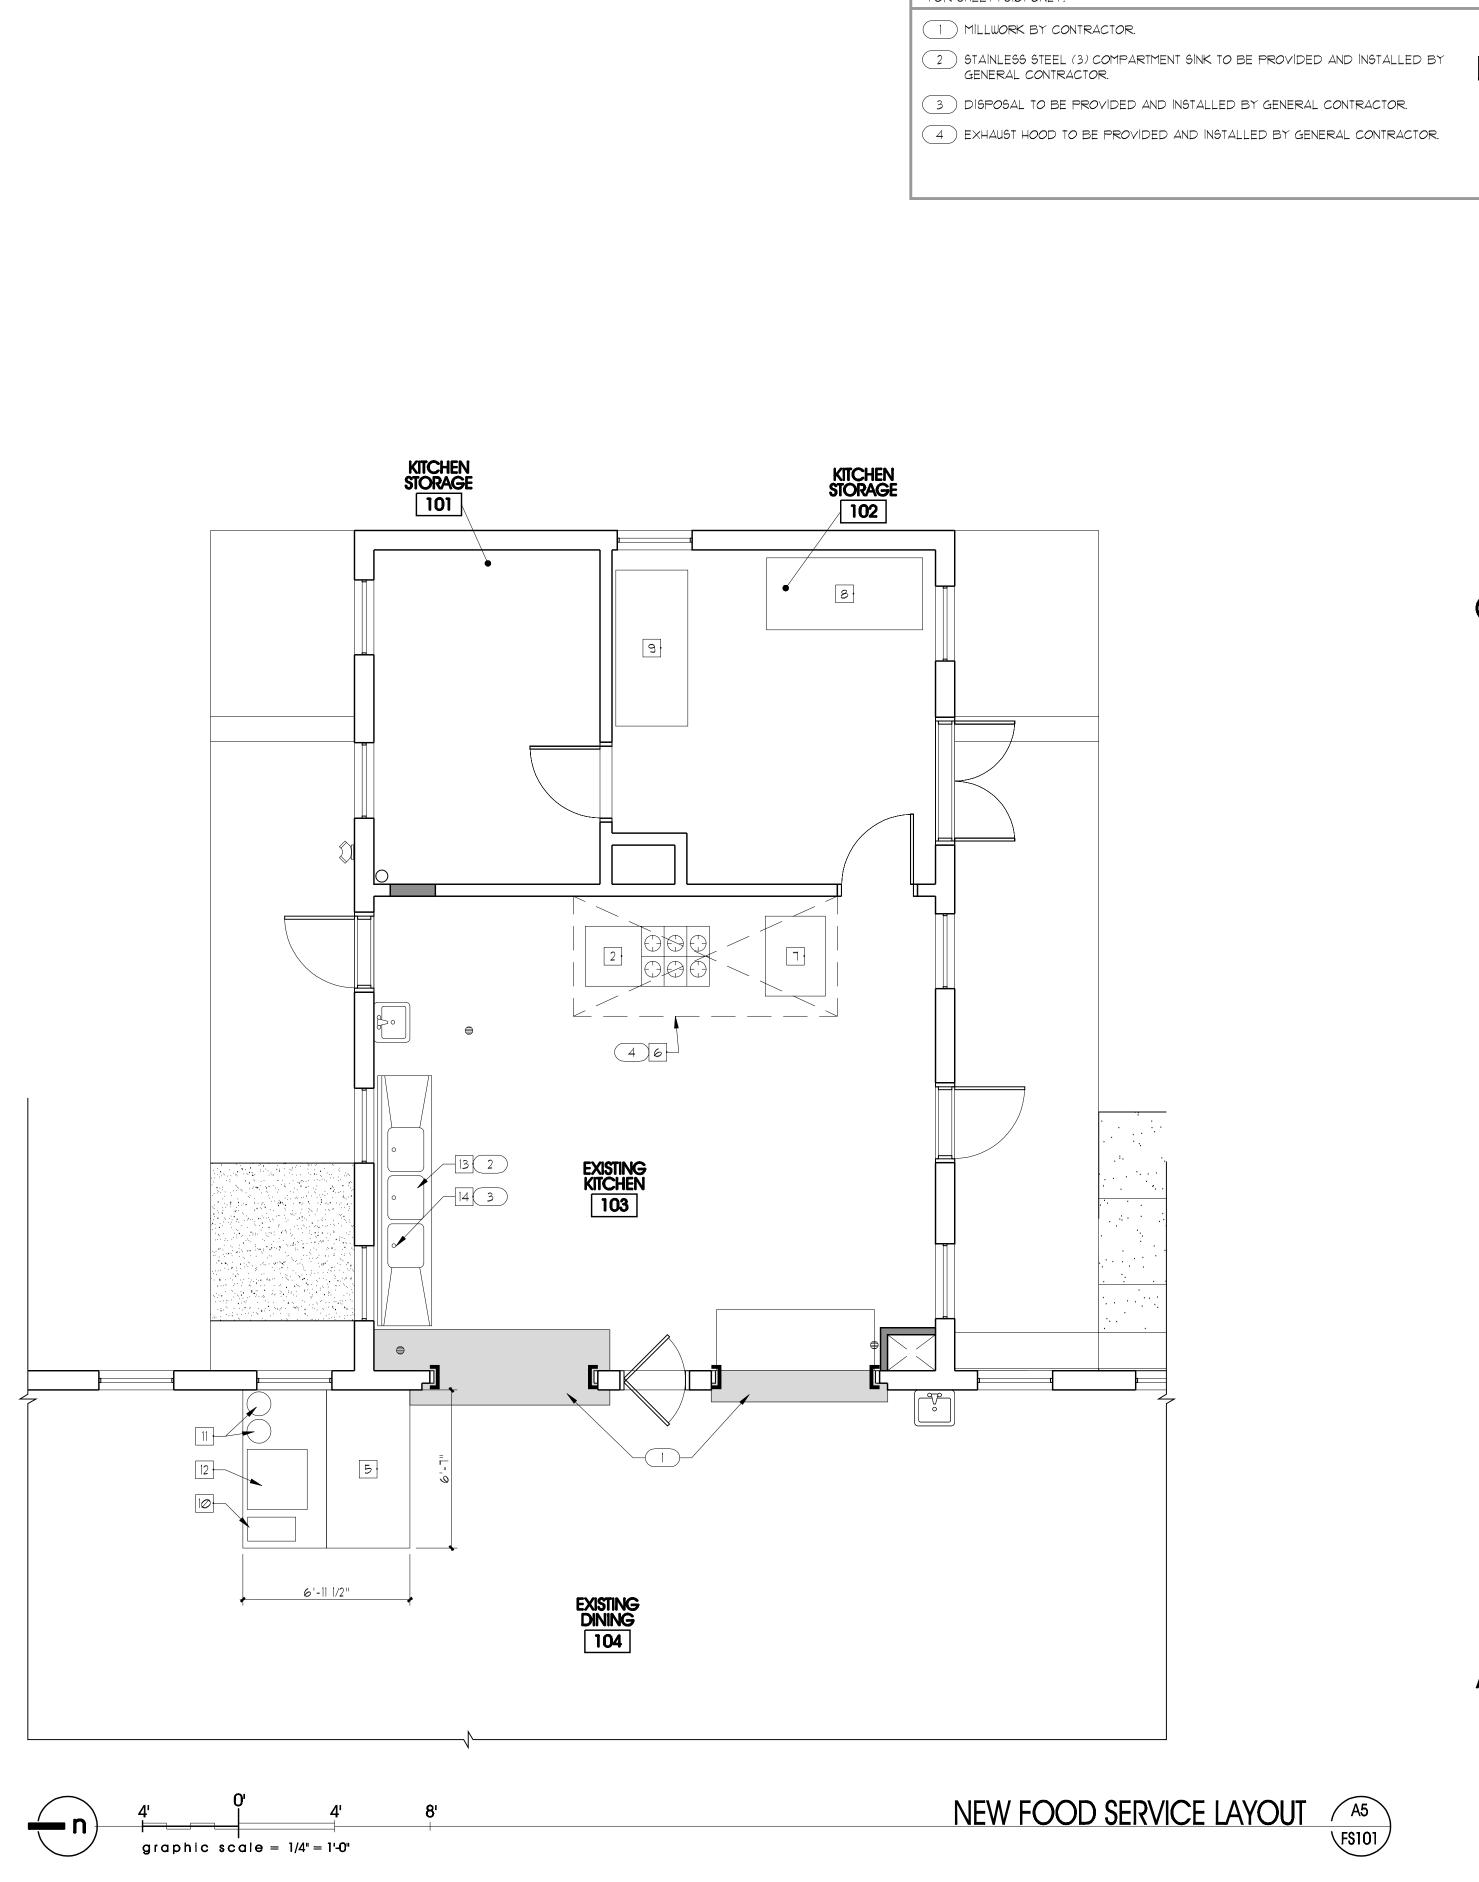

ARCHITECT PROJECT # 0781 ajc architects ALL EQUIPMENT WILL BE PURCHASED AND INSTALLED BY UTAH NATIONAL GUARD, U.N.O.
GENERAL CONTRACTOR TO PROVIDE ROUGH-IN ONLY & ASSOCIATED I HR. RATED
ENCLOSURE & EXHAUST WORK @ HOODS. 703 east 1700 south salt lake city, utah 84105 ph: 801.466.8818 fx: 801.466.4411 ajc@ajcarchitects.com PROJECT DESCRIPTION

GENERAL NOTES AND LEGEND:

NEW KEYED NOTE LEGEND:

*FOR SHEET FS101 ONLY.

DO NOT SCALE DRAWINGS.

 SEE SHEET GIØØ2 FOR GENERAL NOTES. SEE COVER SHEET FOR DRAWING INDEX.

> Salt Lake City, Utah 84114 Phone: (801) 538 - 3018 Fax: (801) 538 - 3267 Internet: http://www.dfcm.utah.gov CAMP WILLIAMS BUILDINGS 5080 AND 5100

State of Utah
Department of Administrative Services

Division of Facilities Construction & Management 4110 State Office Building

NEW FOOD SERVICE LAYOUT

SHEET NAME:

REVISIONS

DATE DESCRIPTION

ISSUE DATA

MAY 2008 CDS BJR KRR CHECKED BY: CAD FILE NAME: 0310F\$101

DFCM PROJECT # **07332480** CONTRACT # 087184 DFCM COPYRIGHT:

SHEET NUMBER:

FS101

5

	LEGEND											
MEANING	SYMBOL OR ABBREVIATION	MEANING	SYMBOL OR ABBREVIATION									
HOT WATER LINE		WALL CLEANOUT	WCO									
HOT WATER RECIRC LINE		CLEANOUT	CO									
COLD WATER LINE		CLEANOUT TO GRADE	COTG									
VENT LINE		FLOOR CLEANOUT	FCO									
WASTE LINE		BALL VALVE	Ф									
VENT THRU ROOF	VTR	UNION	—									

	GENER	RAL LEGEND
NOT ALL SYM	•	ARE USED ON THIS SET OF PLUMBING DRAWINGS
SYMBOL	ABR.	DESCRIPTION
	AFF	ABOVE FINISHED FLOOR
	AP	ACCESS PANEL
	CI	CAST IRON
	d- el.	CENTER LINE ELEVATION
	СС	CONTROL CONTRACTOR
	EC	ELECTRICAL CONTRACTOR
	FPC	FIRE PROTECTION CONTRACTOR
	GC	GENERAL CONTRACTOR
INV. ELEV.		INVERT ELEVATION
	MC	MECHANICAL CONTRACTOR
	NIC	NOT IN CONTRACT
	NTS	NOT TO SCALE
	VCP	VITRIFIED CLAY PIPE
WH-1		PLUMBING FIXTURE AND/OR EQUIPMENT DESIGNATION (TYPICAL)

PLUMBING GENERAL NOTES:

- ALL PLUMBING SHALL BE INSTALLED AND CONFORM TO THE 2006 EDITION OF THE INTERNATIONAL PLUMBING CODE (IPC) WITH UTAH ANNOTATIONS AND LOCAL AUTHORITY REQUIREMENTS.
- ALL PIPING MATERIALS SHALL MEET ALL REQUIREMENTS OF IPC AND LOCAL AUTHORITY. PLASTIC PIPING SHALL BE ALLOWED ONLY WHERE ALLOWED BY CODE. PLASTIC PIPING SHALL NOT BE ROUTED THROUGH RETURN AIR PLENUMS OR OTHER AREAS PROHIBITED BY THE IMC, IPC OR NFPA CODES OR BY LOCAL AUTHORITY
- GAS PIPING INSTALLATION SHALL BE IN STRICT ACCORDANCE WITH GAS COMPANY REGULATIONS, NFPA CODE REQUIREMENTS, AND LOCAL AUTHORITY.
- ALL MATERIALS SHALL BE NEW AND SHALL BE DOMESTIC MADE UNLESS SPECIFICALLY APPROVED OTHERWISE IN WRITING BY ARCHITECT OR OWNER.
- PROVIDE VACUUM BREAKERS AND BACK FLOW PREVENTERS WHERE REQUIRED BY CODE OR WHERE THERE MAY BE ANY POSSIBLE CHANCE FOR CROSS CONTAMINATION. PREVENTERS SHALL BE INSTALLED IN ACCORDANCE WITH UTAH CODE.
- ALL PLUMBING INFORMATION IS NOT LIMITED TO THE PLUMBING DRAWINGS. CONTRACTOR SHALL BE RESPONSIBLE FOR INFORMATION ON ALL OTHER CONSTRUCTION DOCUMENTS INCLUDING ARCHITECTURAL DRAWING, STRUCTURAL DRAWINGS, MECHANICAL DRAWINGS, AND ELECTRICAL DRAWINGS.
- THE WORKING DRAWINGS ARE DIAGRAMMATIC. BECAUSE OF THE SMALL SCALE OF THE DRAWING, THEY DO NOT SHOW EVERY OFFSET, BEND OR ELBOW NECESSARY FOR THE COMPLETE INSTALLATION IN THE SPACE PROVIDED. ALL PIPING SHALL BE CHECKED AND COORDINATED WITH THE ARCHITECTURAL, STRUCTURAL, MECHANICAL, AND ELECTRICAL DRAWINGS.
- COORDINATE ALL PIPING AND PLUMBING EQUIPMENT WITH ALL OTHER TRADES AND/OR CONTRACTORS PRIOR TO INSTALLATION.
- ANY AND ALL ALTERATIONS TO THE SYSTEM SHOWN SHALL BE THE RESPONSIBILITY OF THIS CONTRACTOR AND ARCHITECT/ENGINEER SHALL BE NOTIFIED IN WRITING PRIOR TO CHANGES.
- GAS LINE FITTINGS SHALL BE STANDARD WELD FITTINGS WITH TAPERED REDUCERS. DO NOT USE VALVES, UNIONS, OR AUTO CONTROLS IN GAS LINES ROUTED IN INACCESSIBLE CONCEALED SPACES.
- G-11 ALL WATER SYSTEMS SHALL MEET THE REQUIREMENTS OF ANSI/NSF STANDARD 61 SECTION 9 (1998), CONCERNING METAL CONTAMINANTS IN THE WATER SYSTEM.
- G-12 WATER PIPING SHALL NOT BE ROUTED IN OUTSIDE WALLS OR ON EXTERIOR SIDE OF BUILDING INSULATION ENVELOPE.
- WATER HAMMER ARRESTORS SHALL BE INSTALLED IN ALL WATER LINES WITH QUICK OPEN OR QUICK CLOSE VALVES.

WATER HAMMER ARRESTOR SCHEDULE:

TYPE A 1-11 FIXTURE UNITS TYPE B 12-32 FIXTURE UNITS

TYPE C 33-60 FIXTURE UNITS TYPE D 61-113 FIXTURE UNITS ARCHITECT PROJECT # 0310



ajc architects

703 east 1700 south salt lake city, utah 84105 ph: 801.466.8818 fx: 801.466.4411 ajc@ajcarchitects.com



WHW ENGINEERING INC. PROFESSIONAL MECHANICAL ENGINEERING 1354 East 3300 South Suite 200

SALT LAKE CITY, UTAH 84106 (801)466-4021, FAX 466-8536 EMAIL: excellence@whw-engineering.com PROJECT DESCRIPTION

State of Utah Department of Administrative Services



Division of Facilities Construction & Management 4110 State Office Building Salt Lake City, Utah 84114 Phone: (801) 529 Fax: (801) 538 - 3267

Internet: http://www.dfcm.utah.gov

CAMP WILLIAMS BUILDINGS 5080 AND 5100

SHEET NAME:

PLUMBING GENERAL NOTES AND LEGEND

REVISIONS

MARK DATE DESCRIPTION

ISSUE DATA


ISSUE DATE: NOV 2007 ISSUE TYPE: **BID SET** DRAWN BY: STAFF


CHECKED BY: WP CAD FILE NAME: PG-001.DWG DFCM PROJECT # 02283480


STATE PROPERTY # COPYRIGHT:


SHEET NUMBER:

SHEET 18 OF 35

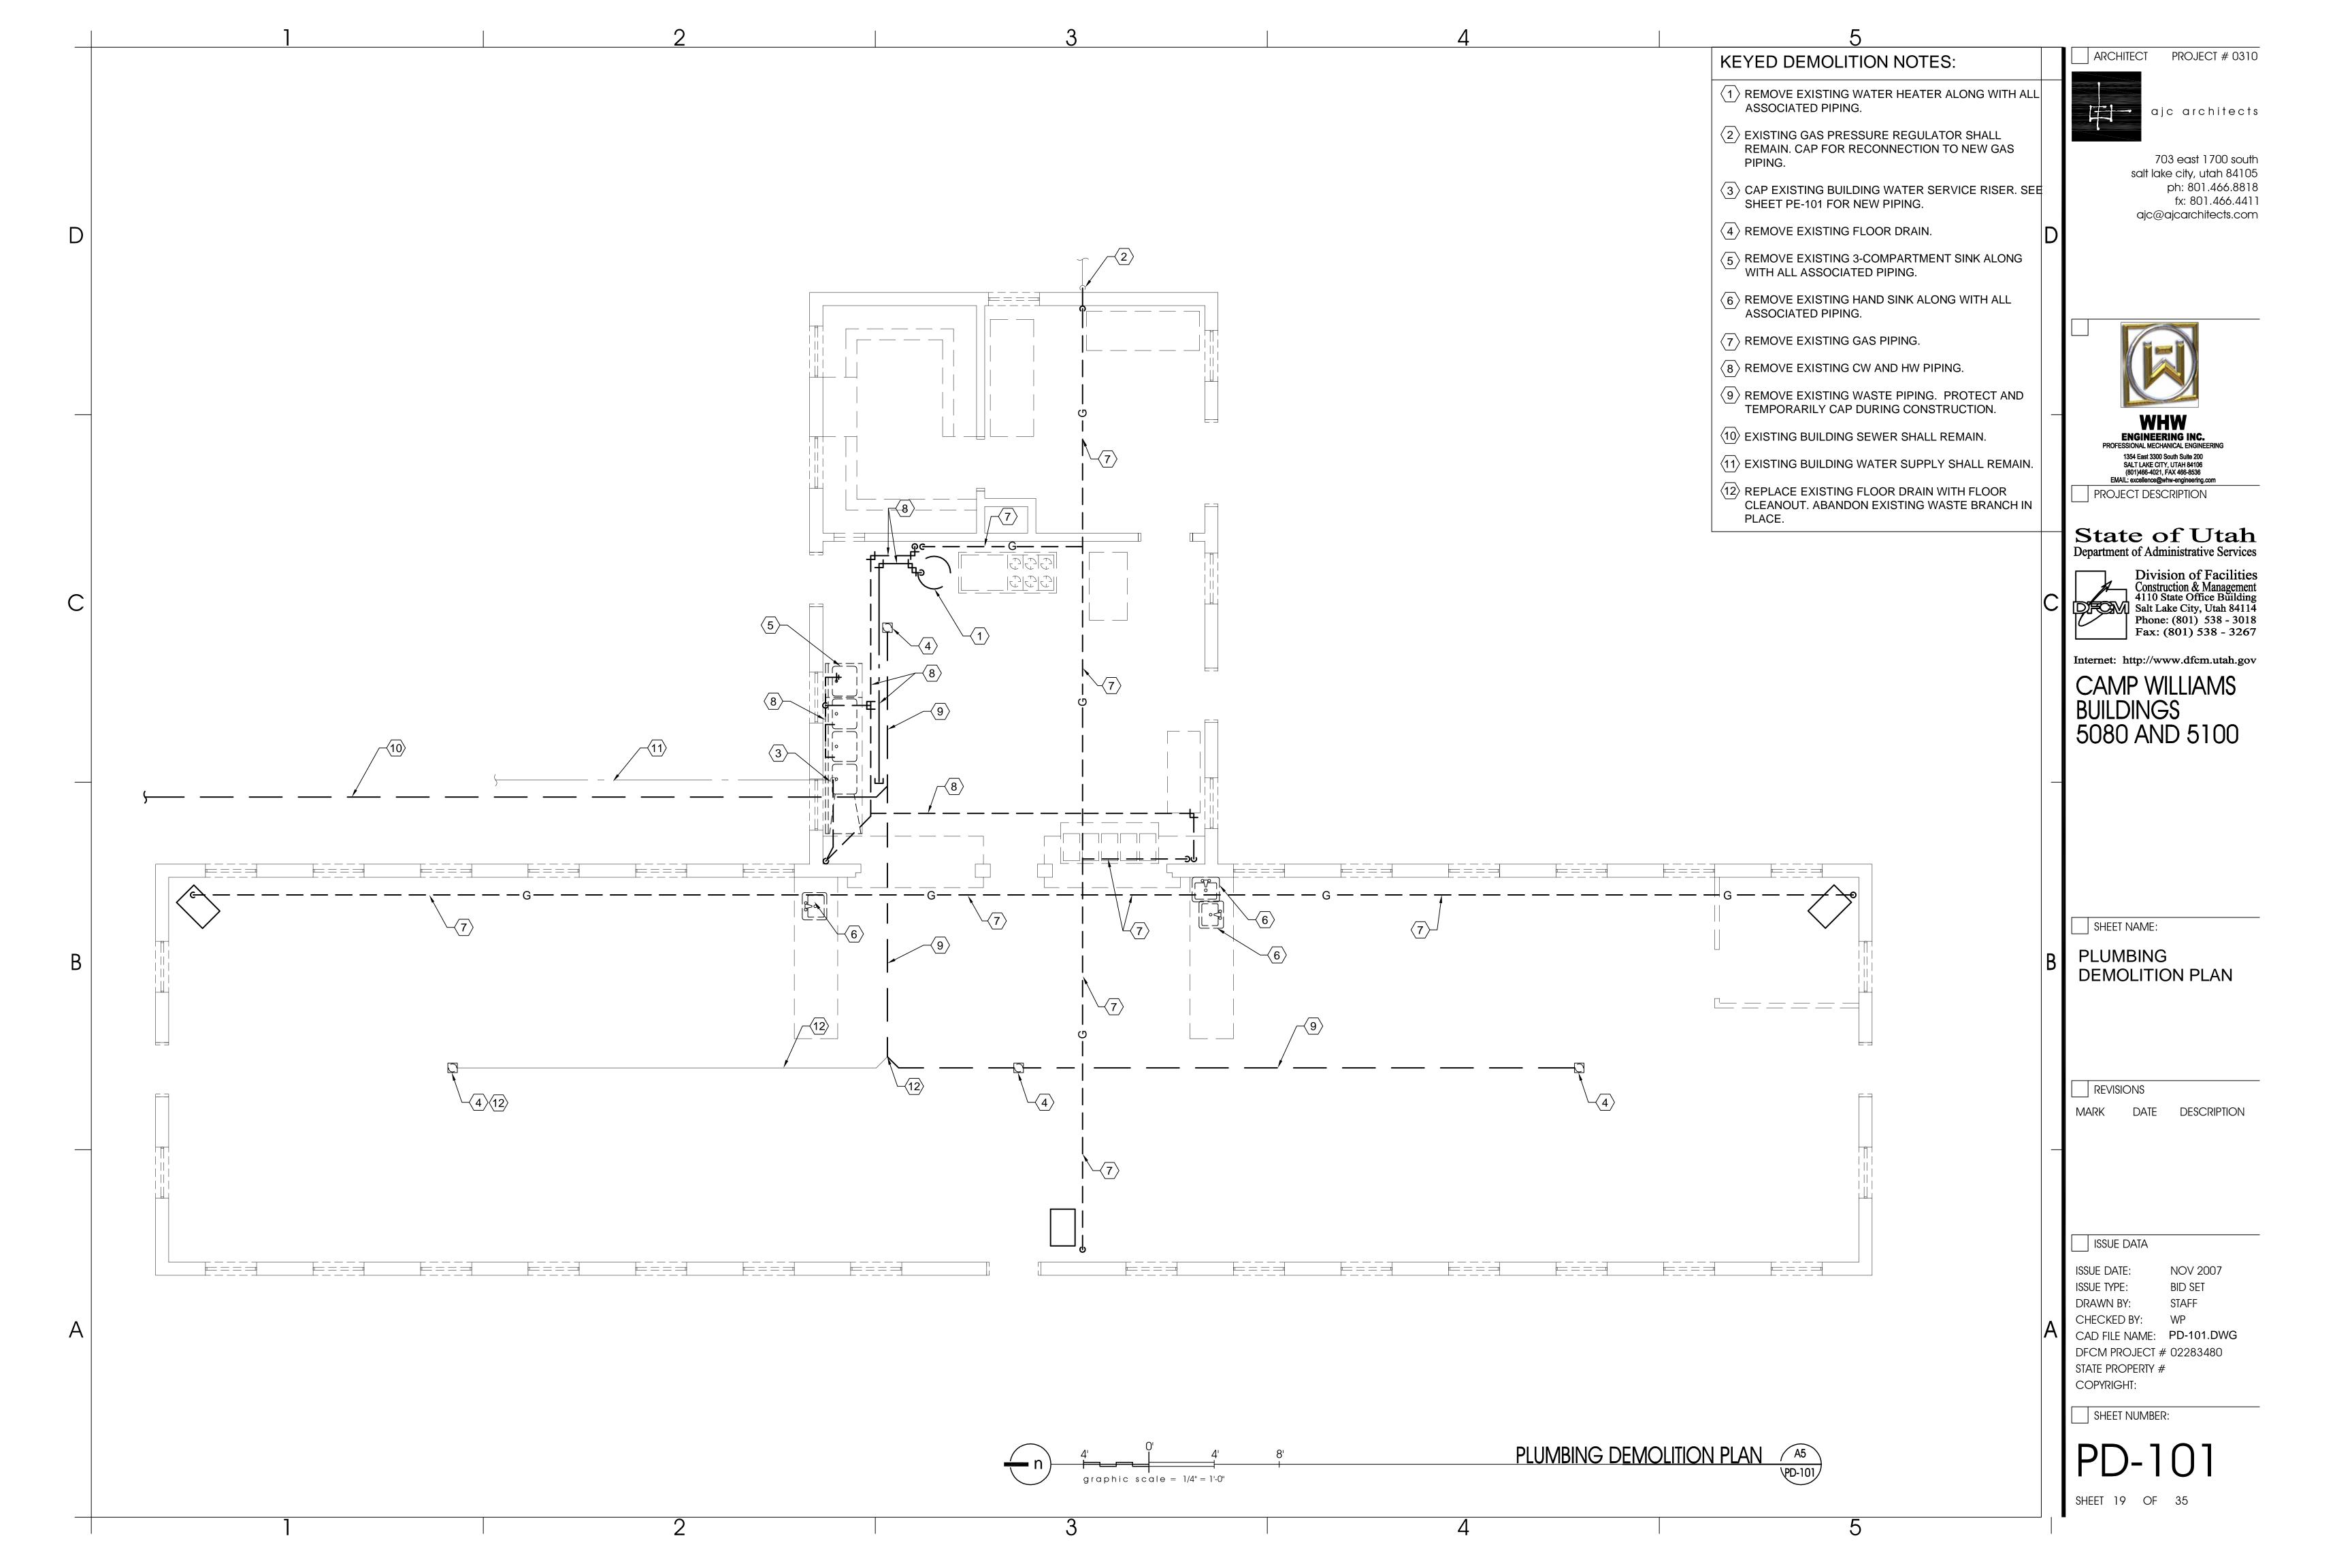

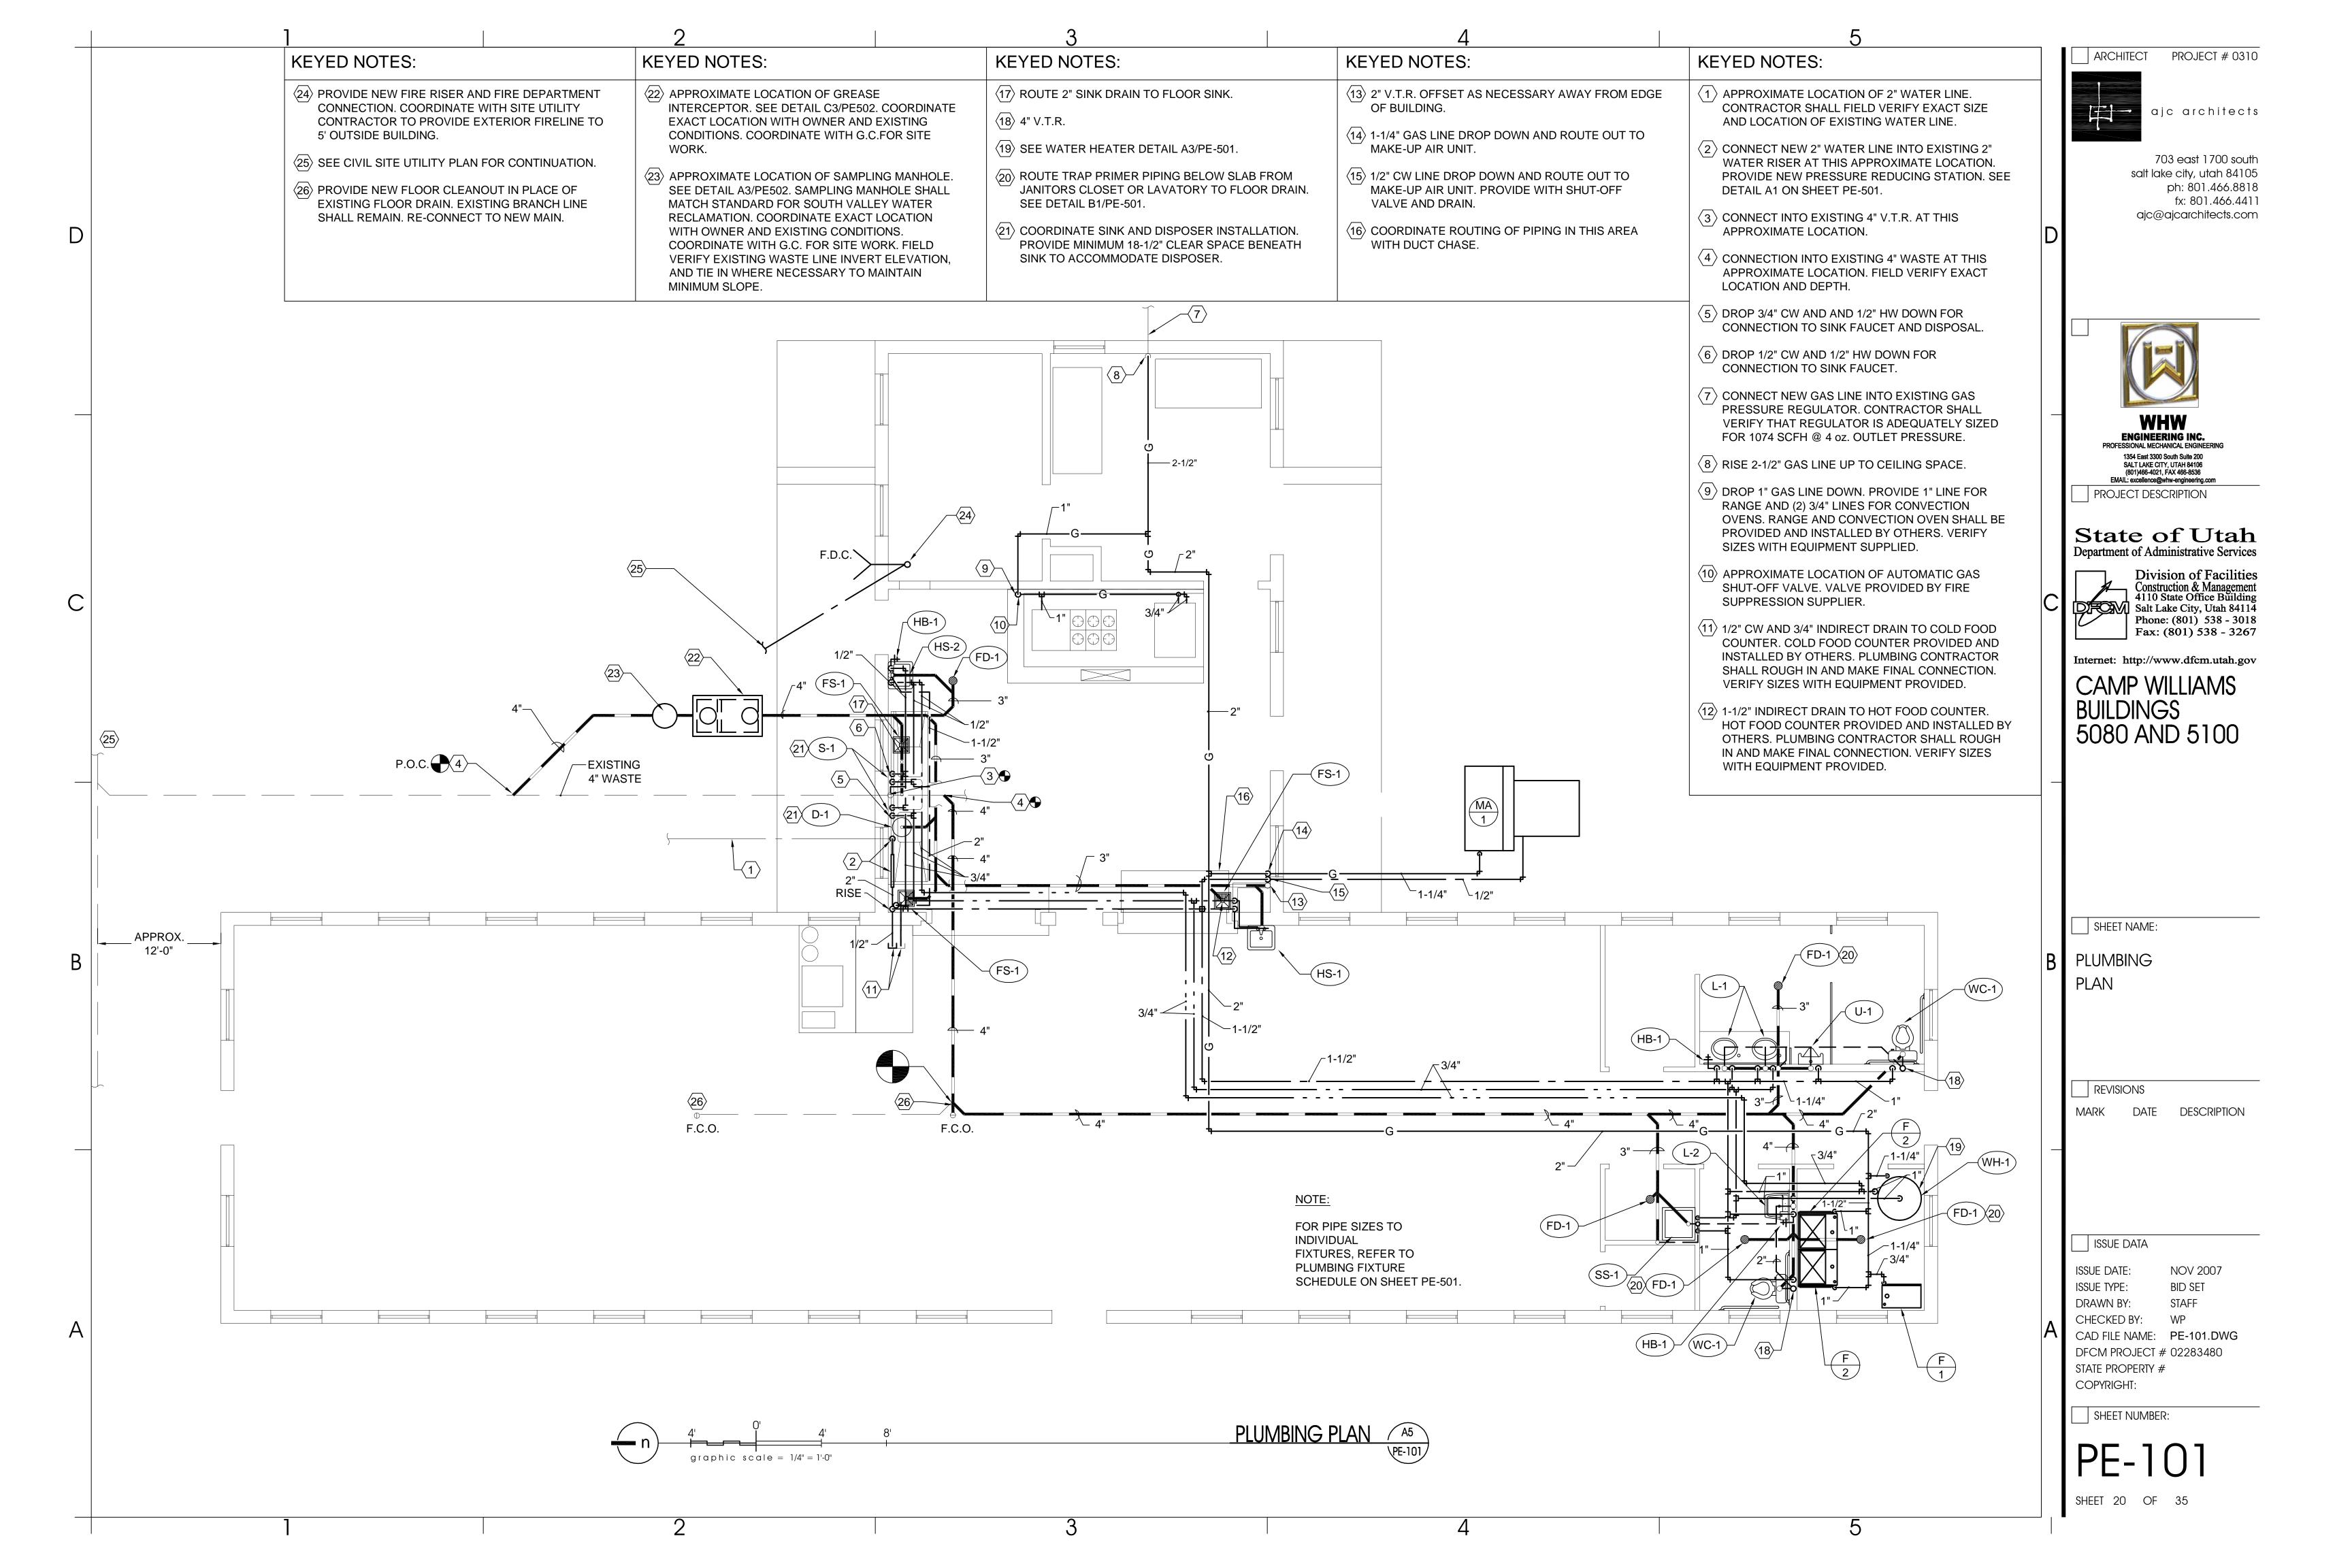

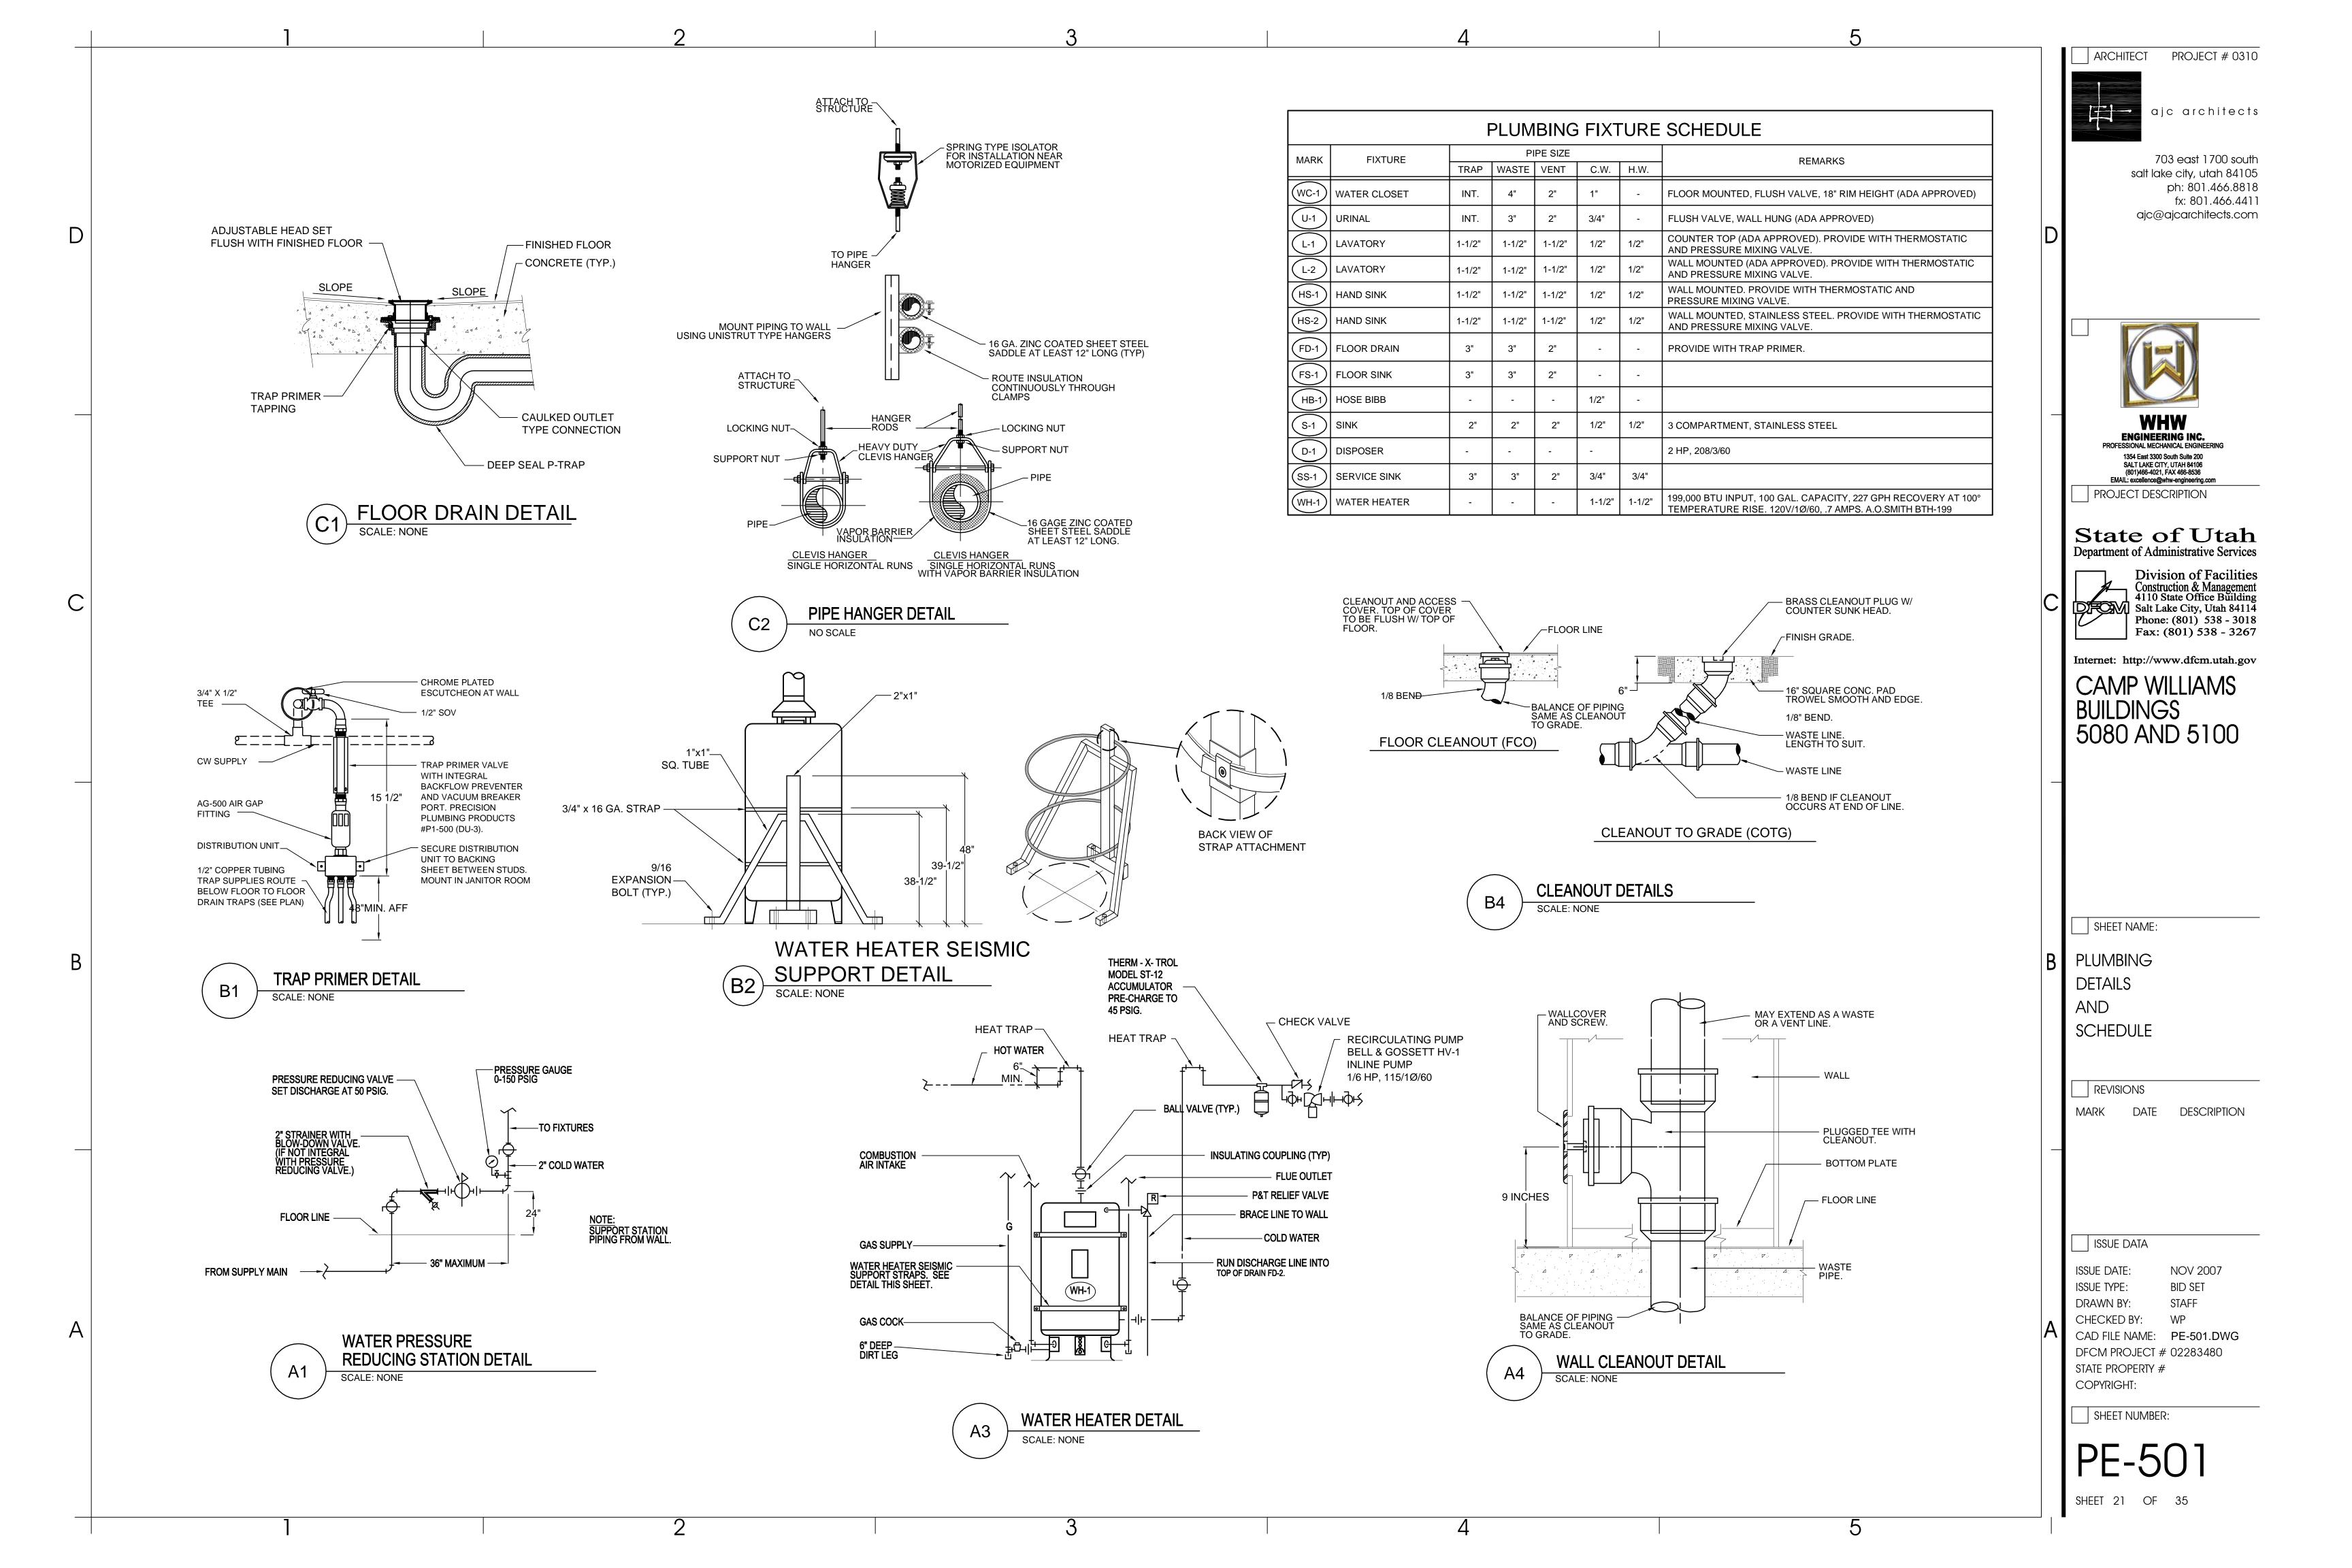

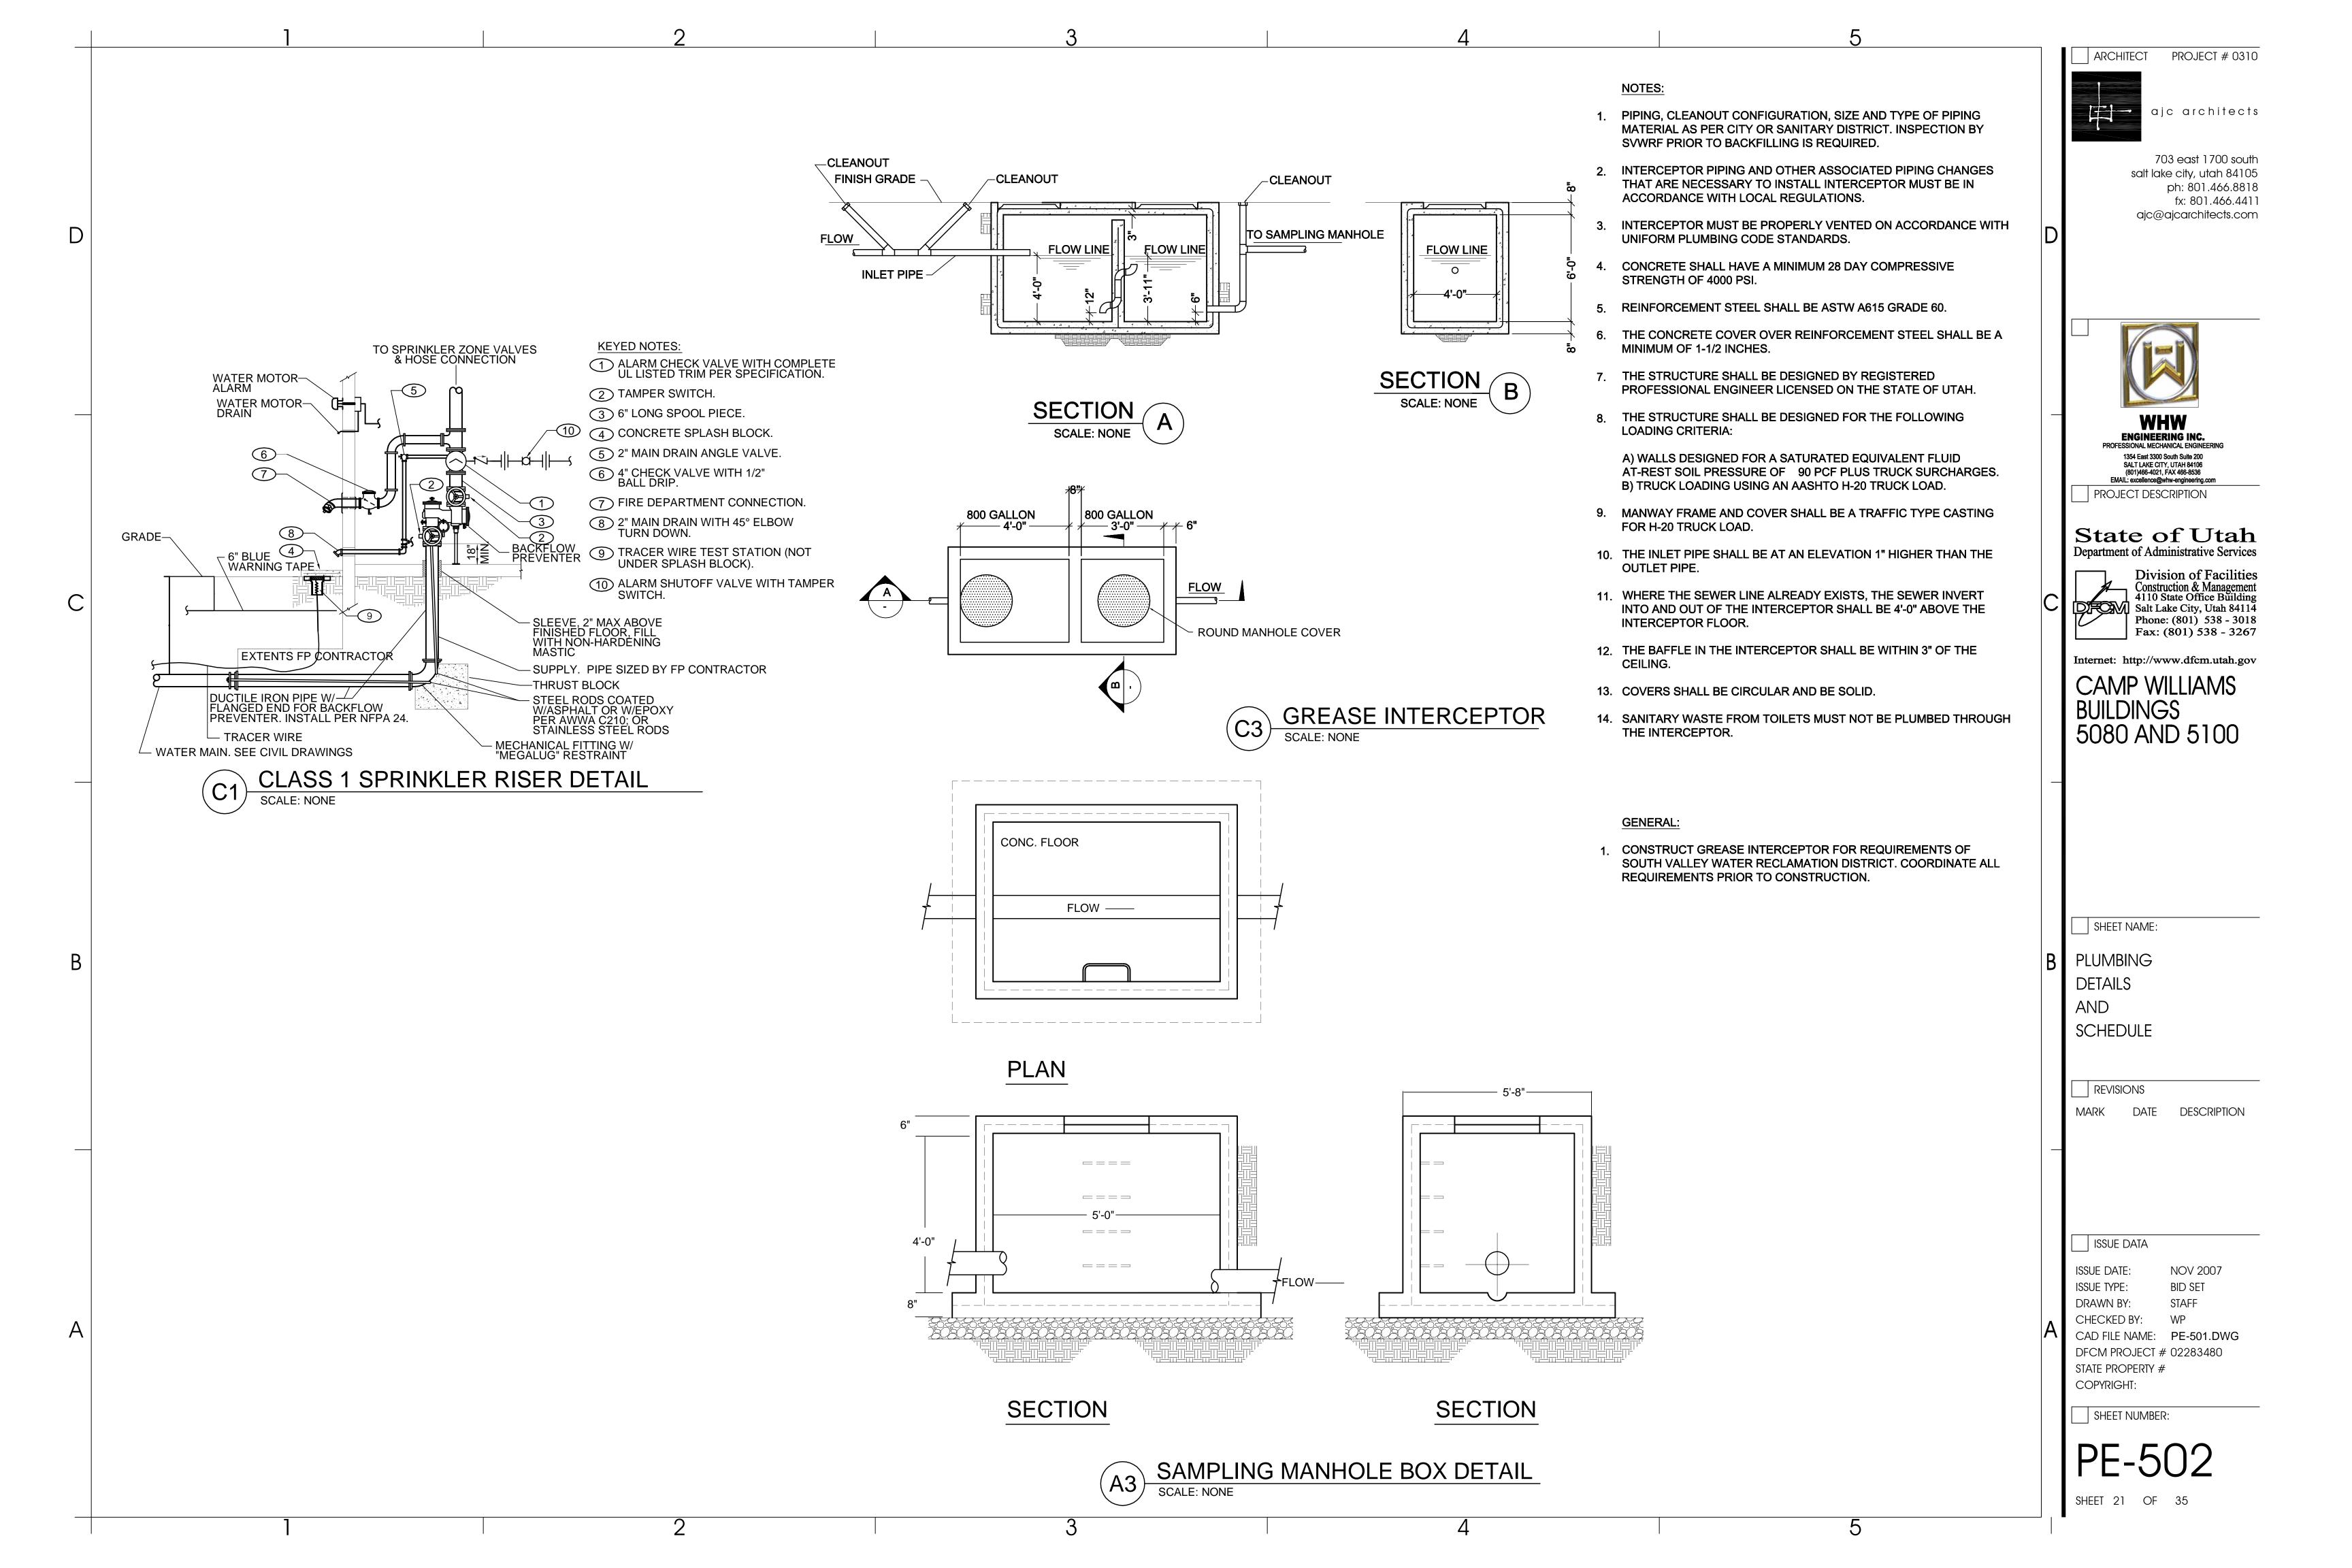

		MECHANIC	AL LE	GE	IND
SYMBOL	ABR.	DESCRIPTION			
₩		EXISTING AIR DUCT TO BE REMOVED			EXISTING EQUIPMENT TO BE REMOVED
		EXISTING AIR DUCT TO REMAIN			EXISTING EQUIPMENT TO REMAIN
₩ 🗗		NEW AIR DUCT			NEW EQUIPMENT
		RECT. TO RECT. AIR DUCT TAKE-OFF	F	FD	FIRE DAMPER
		RECT. TO RND. AIR DUCT TAKE-OFF		T'STAT	WALL MOUNTED THERMOSTAT
		RND. TO RND. AIR DUCT TAKE-OFF	SA		SUPPLY AIR
\)		FLEXIBLE AIR DUCT	RA		RETURN AIR
		LINED DUCT	EA		EXHAUST AIR
The state of the s		VANED ELBOW	A		SECTION LETTER DESIGNATION
		RADIUS ELBOW	M-5		- SECTION DRAWN ON THIS SHEET
∀		CONCENTRIC DUCT TRANSITION			
H		ECCENTRIC DUCT TRANSITION	(A1)		- DETAIL NUMBER DESIGNATION
		FLEXIBLE DUCT CONNECTION	AH		- MECHANICAL EQUIPMENT DESIGNATION
		VOLUME DAMPER	1_		- EQUIPMENT ITEM DESIGNATION
		SUPPLY AIR DIFFUSER	Â		REVISION DESIGNATOR AND NUMBER
		RETURN AIR, FRESH AIR, AND TRANSFER AIR	1		KEY NOTE DESIGNATOR AND NUMBER
		CEILING MOUNTED EXHAUST FAN OR EXHAUST GRILLE	•	POC	POINT OF CONNECTION
		RETURN OR OUTSIDE AIR DUCT UP	GC		GENERAL CONTRACTOR
		SUPPLY DUCT UP	MC		MECHANICAL CONTRACTOR
		EXHAUST AIR INTAKE UP	NIC		NOT IN CONTRACT
		RETURN OR OUTSIDE AIR DUCT DOWN			
		SUPPLY DUCT DOWN			
		EXHAUST DUCT DOWN			
		ROUND DUCT UP			
		ROUND DUCT DOWN			

GENERAL NOTES:

MECHANICAL INFORMATION IS NOT LIMITED TO THE MECHANICAL DRAWINGS. CONTRACTOR SHALL BE RESPONSIBLE FOR INFORMATION ON ALL OTHER CONSTRUCTION DOCUMENTS INCLUDING DRAWINGS BY OTHER DISCIPLINES AND SPECIFICATIONS.

> A - EACH DRAWING SHEET AND THE SPECIFICATIONS HAVE BEEN PREPARED TO SUPPLEMENT EACH OTHER AND THEY SHALL BE INTERPRETED AS AN INTEGRAL UNIT WITH ITEMS SHOWN AND NOTED ON ONE AND NOT THE OTHER BEING FURNISHED AND INSTALLED AS THOUGH SHOWN AND CALLED OUT IN ALL PLACES. ITEMS IN SPECIFICATIONS OR DRAWINGS LISTED WHICH ARE DIFFERING IN EFFICIENCY OR QUALITY SHALL BE HELD TO THE GREATEST OF: EFFICIENCY, QUALITY OR GOVERNING CODE.

B - THE CONTRACTOR WILL BE HELD RESPONSIBLE FOR THE INSTALLATION OF THE SYSTEMS ACCORDING TO THE TRUE INTENT AND MEANING OF THE CONTRACT DOCUMENTS.

C - THE CONTRACTOR SHALL INSTALL ALL EQUIPMENT WITH PROPER SERVICE ACCESS AND CLEARANCES ACCORDING TO MANUFACTURERS RECOMMENDATIONS. THE CONTRACTOR SHALL REVIEW SUPPLIERS BID PACKAGES FOR COMPLETENESS AND COMPLIANCE TO THE SPECIFICATIONS, SCHEDULES, AND DESIGN INTENT (ALL EQUIPMENT AND METHODS). THE CONTRACTOR SHALL REMOVE AND REINSTALL CORRECTLY AT HIS OWN EXPENSE ANY EQUIPMENT NOT IN COMPLIANCE.

D - THE CONTRACTOR SHALL CONSULT MANUFACTURERS INSTALLATION INSTRUCTIONS FOR SIZES, METHODS, ACCESSORIES, AND CLEARANCES IN SPACE AVAILABLE PRIOR TO BIDDING PROJECT

E - ANYTHING NOT CLEAR OR IN CONFLICT WILL BE EXPLAINED BY MAKING APPLICATION TO THE ENGINEER IN WRITING.

ANY AND ALL ALTERATIONS TO THE SYSTEM SHOWN SHALL BE SUBMITTED TO THE ENGINEER PRIOR TO CHANGES FOR APPROVAL CONTRACTOR SHALL NOT START ANY CHANGES UNTIL NOTIFIED IN WRITING. IF CHANGES ARE MADE PRIOR TO APPROVAL CONTRACTOR SHALL TAKE ALL RESPONSIBILITY FOR THE CHANGES MADE AND ALL COSTS RELATING TO FAILURE OR REPLACEMENT OF ALTERATIONS.

CONTRACTOR SHALL FIELD VERIFY ALL DIMENSIONS AND LOCATIONS.

THE WORKING DRAWINGS ARE DIAGRAMMATIC. THEY DO NOT SHOW EVERY OFFSET, BEND, OR ELBOW NECESSARY FOR THE COMPLETE INSTALLATION IN THE SPACE PROVIDED. ALL LOCATIONS FOR MECHANICAL EQUIPMENT SHALL BE FIELD VERIFIED AND COORDINATED WITH ALL DRAWINGS. THE CONTRACTOR SHALL PROVIDE OR COORDINATE WITH THE GENERAL CONTRACTOR PROVISIONS FOR BLOCKOUTS OR CORE DRILLS THROUGH STRUCTURE.

THE INSTRUCTION TO "PROVIDE" ALSO INCLUDES INSTALLATION.

MECHANICAL CONTRACTOR SHALL PROVIDE AND INSTALL SMOKE AND FIRE DAMPERS AS REQUIRED BY LOCAL CODES AND AUTHORITIES.

SHEET METAL DUCT SIZES SHOWN ON DRAWINGS ARE FREE AREA DIMENSIONS.

PROVIDE AND INSTALL BALANCING DAMPERS IN ALL SUPPLY AND EXHAUST AIR BRANCH DUCTS. BALANCE TO CFM SHOWN ON PLAN.

SEE ARCHITECTURAL REFLECTED CEILING PLAN FOR EXACT LOCATION OF DIFFUSERS AND GRILLES.

PROVIDE TURNING VANES IN ALL ELBOWS OF RECTANGULAR DUCT.

THE CONTRACTOR SHALL ASSUME ALL RESPONSIBILITY IN HANDLING AND DISPOSING OF REFRIGERANTS, OILS, ETC. ALL SUCH MATERIALS SHALL BE HANDLED, DISPOSED, AND USED IN ACCORDANCE WITH ALL LOCAL, STATE, AND FEDERAL LAWS.

THE MECHANICAL CONTRACTOR SHALL VERIFY MOTOR VOLTAGES WITH THE ELECTRICAL DRAWING BEFORE ORDERING MOTORIZED EQUIPMENT AND CONTROLS.

C.F.M. LISTED IS ACTUAL AIR.

SUPPLIERS SHALL REVIEW ALL DRAWINGS AND THE SPECIFICATIONS PRIOR TO SUBMITTING PRICES TO THE CONTRACTOR. ALL QUESTIONS AND DISCREPANCIES SHALL BE BROUGHT TO THE ENGINEERS ATTENTION PRIOR TO BIDDING.

CONTRACTOR SHALL THOROUGHLY REVIEW AND SIGN SUBMITTALS FOR COMPLETENESS AND COMPLIANCE TO THE SPECIFICATIONS PRIOR TO ENGINEERS REVIEW. SUPPLIERS SHALL HIGHLIGHT OR MARK ALL INFORMATION REQUIRED TO SHOW COMPLIANCE TO THE SPECIFICATIONS. ALL REQUESTED EXCEPTIONS TO THE SPECIFICATIONS, OR SCHEDULES SHALL BE CLEARLY NOTED AND EXPLAINED. SUBMITTAL REVIEW AND ACCEPTANCE IS FOR DESIGN CONCEPT ONLY, AND DOES NOT AT ANY TIME RELIEVE THE CONTRACTOR OF RESPONSIBILITY TO MEET SPECIFICATIONS, CAPACITIES, OR DESIGN INTENT.

ALL MECHANICAL SHALL BE INSTALLED AND CONFORM TO THE 2006 EDITION OF THE IMC WITH UTAH ANNOTATIONS AND LOCAL AUTHORITY REQUIREMENTS.

THIS CONTRACTOR SHALL BE RESPONSIBLE FOR THE DRAINING DOWN AND RE-FILLING OF ALL SYSTEMS NECESSARY TO COMPLETE THE WORK OUTLINED BY THIS PROJECT. THIS INCLUDES PROVIDING THE REQUIRED CHEMICAL TREATMENT WHEN RE-FILLING THE SYSTEM.

ALL PIPING, MATERIALS, ETC. SHALL BE NEW AND DOMESTIC MADE UNLESS SPECIFICALLY AUTHORIZED IN WRITING PRIOR TO BID.

ARCHITECT PROJECT # 0310



ajc architects

703 east 1700 south salt lake city, utah 84105 ph: 801.466.8818 fx: 801.466.4411 ajc@ajcarchitects.com



WHW ENGINEERING INC. PROFESSIONAL MECHANICAL ENGINEERING 1354 East 3300 South Suite 200 SALT LAKE CITY, UTAH 84106

(801)466-4021, FAX 466-8536 EMAIL: excellence@whw-engineering.com PROJECT DESCRIPTION

State of Utah Department of Administrative Services



Division of Facilities — Construction & Management Salt Lake City, Utah 84114
Phone: (801) 538 - 3018 Fax: (801) 538 - 3267

Internet: http://www.dfcm.utah.gov

CAMP WILLIAMS BUILDINGS 5080 AND 5100

SHEET NAME:

MECHANICAL **NOTES** AND LEGEND

REVISIONS


DATE DESCRIPTION


ISSUE DATA


ISSUE DATE: NOV 2007 ISSUE TYPE: **BID SET** DRAWN BY: STAFF CHECKED BY: WP CAD FILE NAME: MG-001.DWG DFCM PROJECT # 02283480 STATE PROPERTY # COPYRIGHT:


SHEET NUMBER:


SHEET 22 OF 35

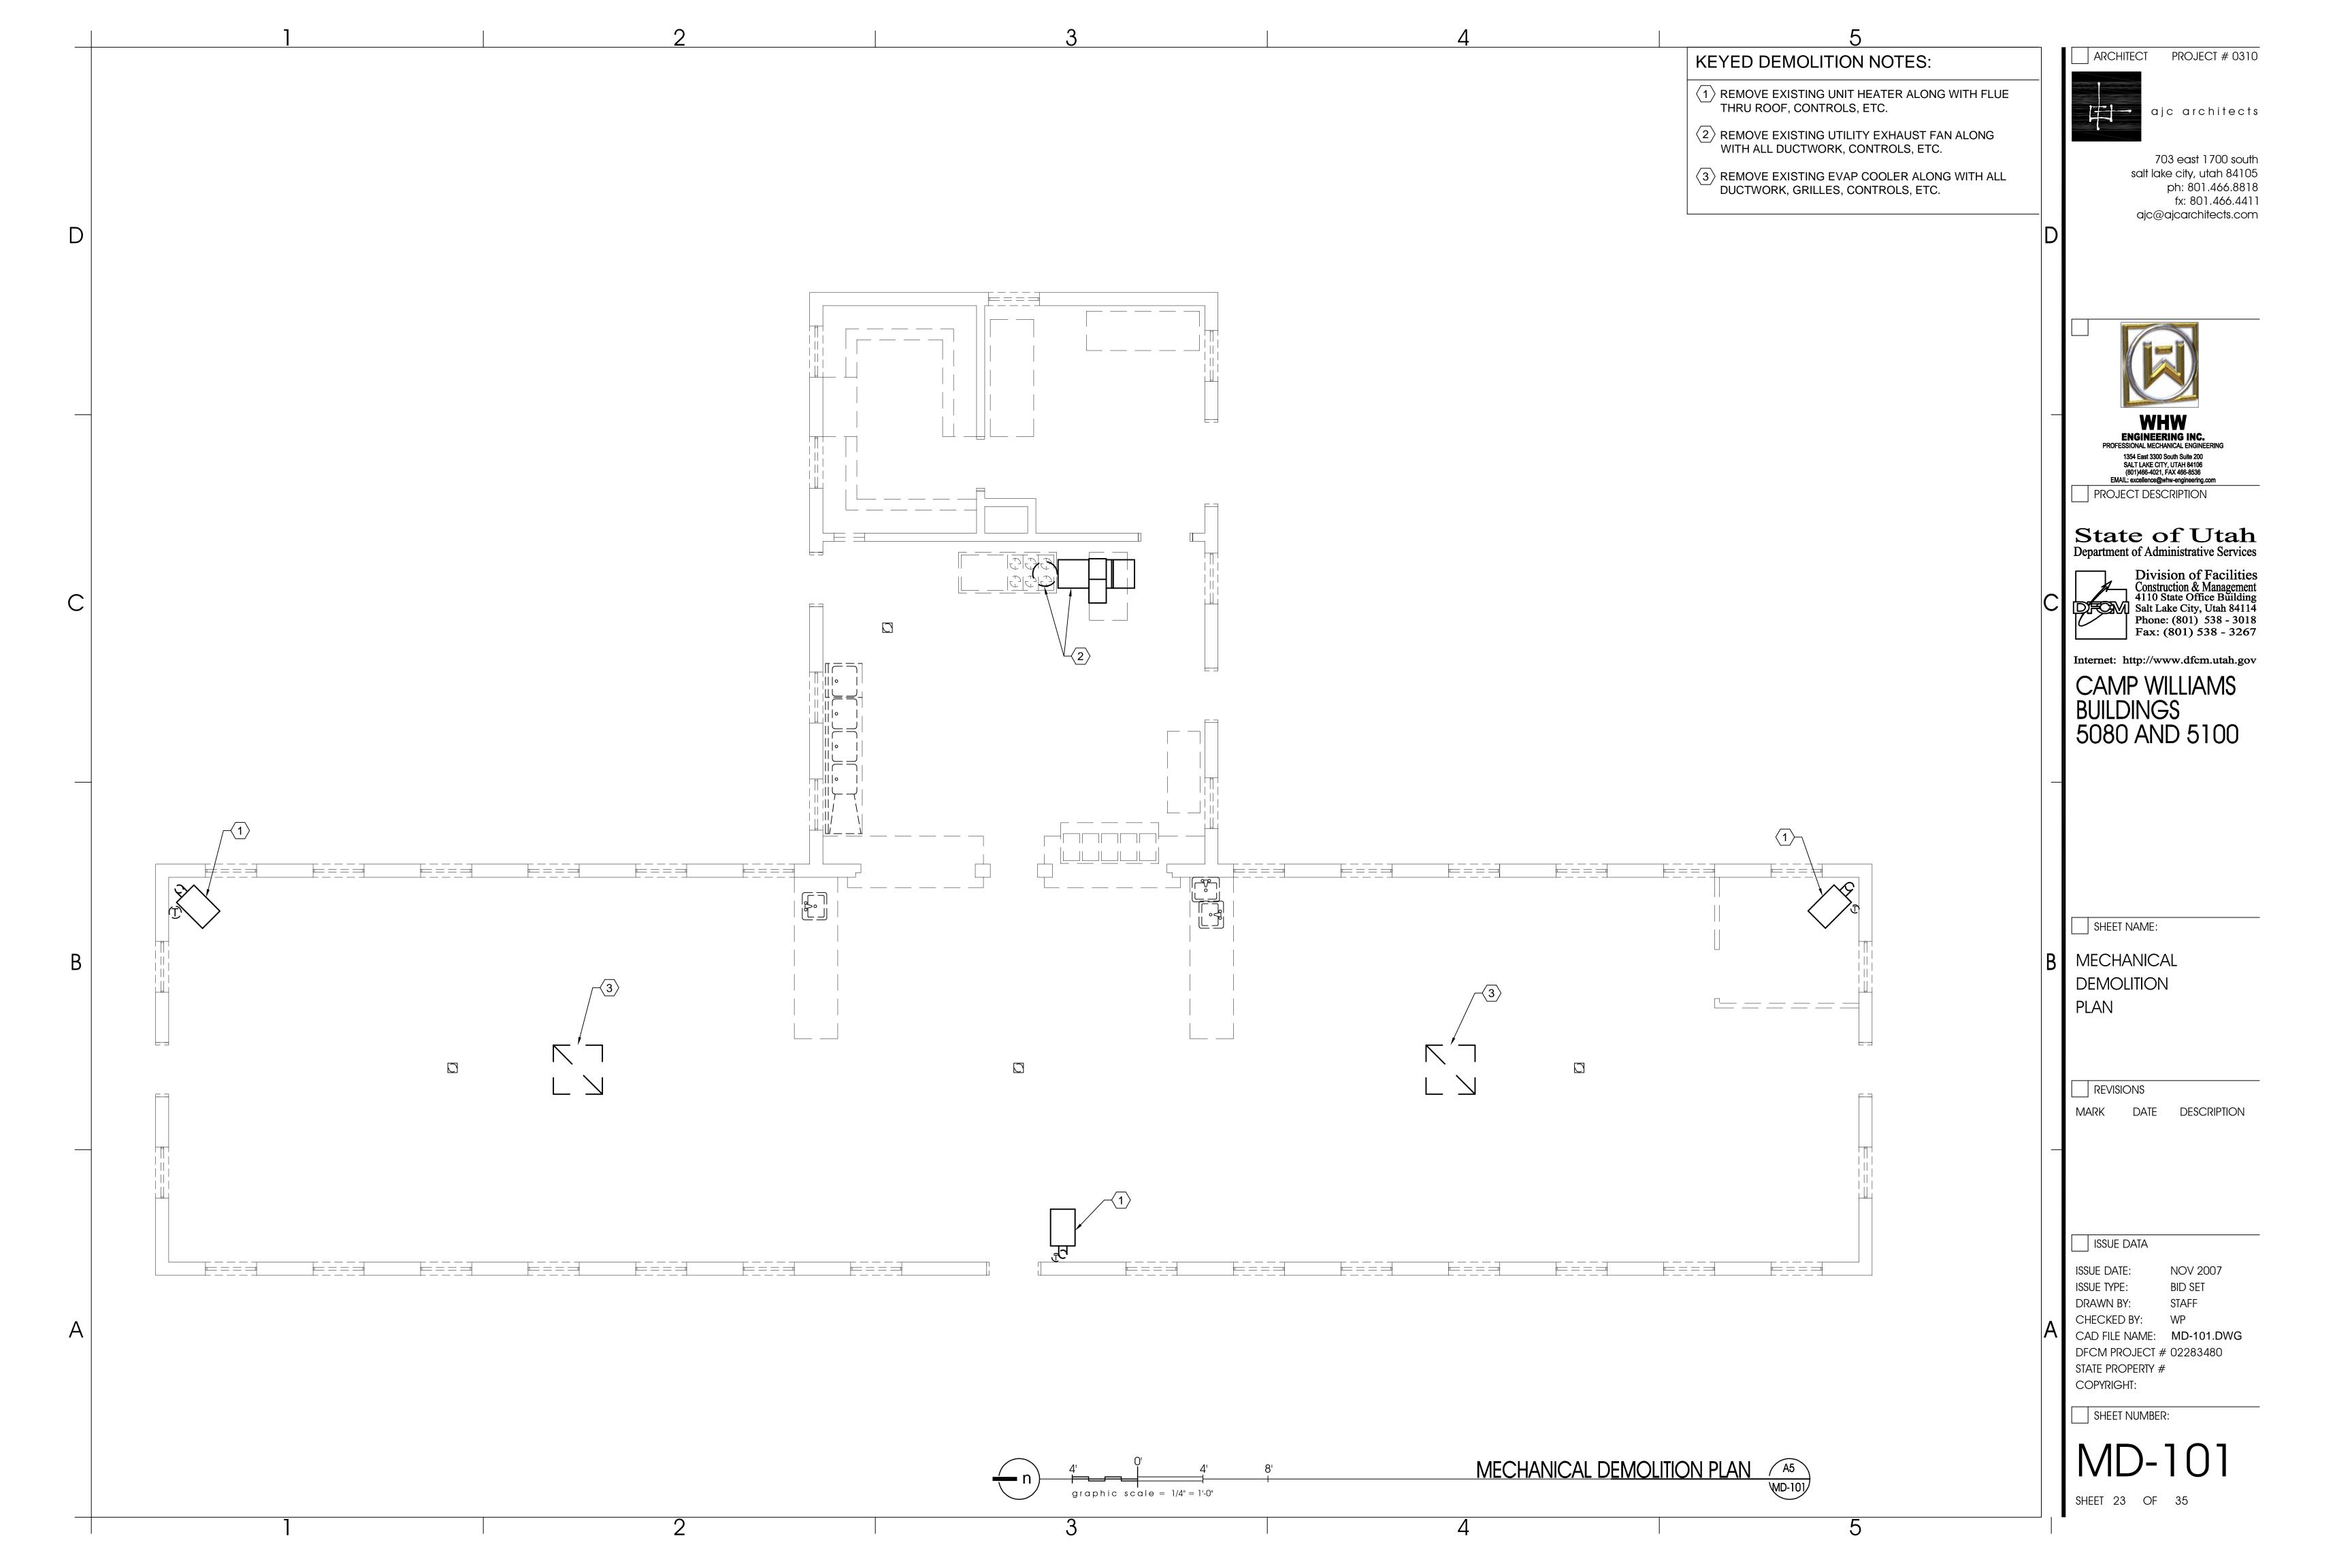

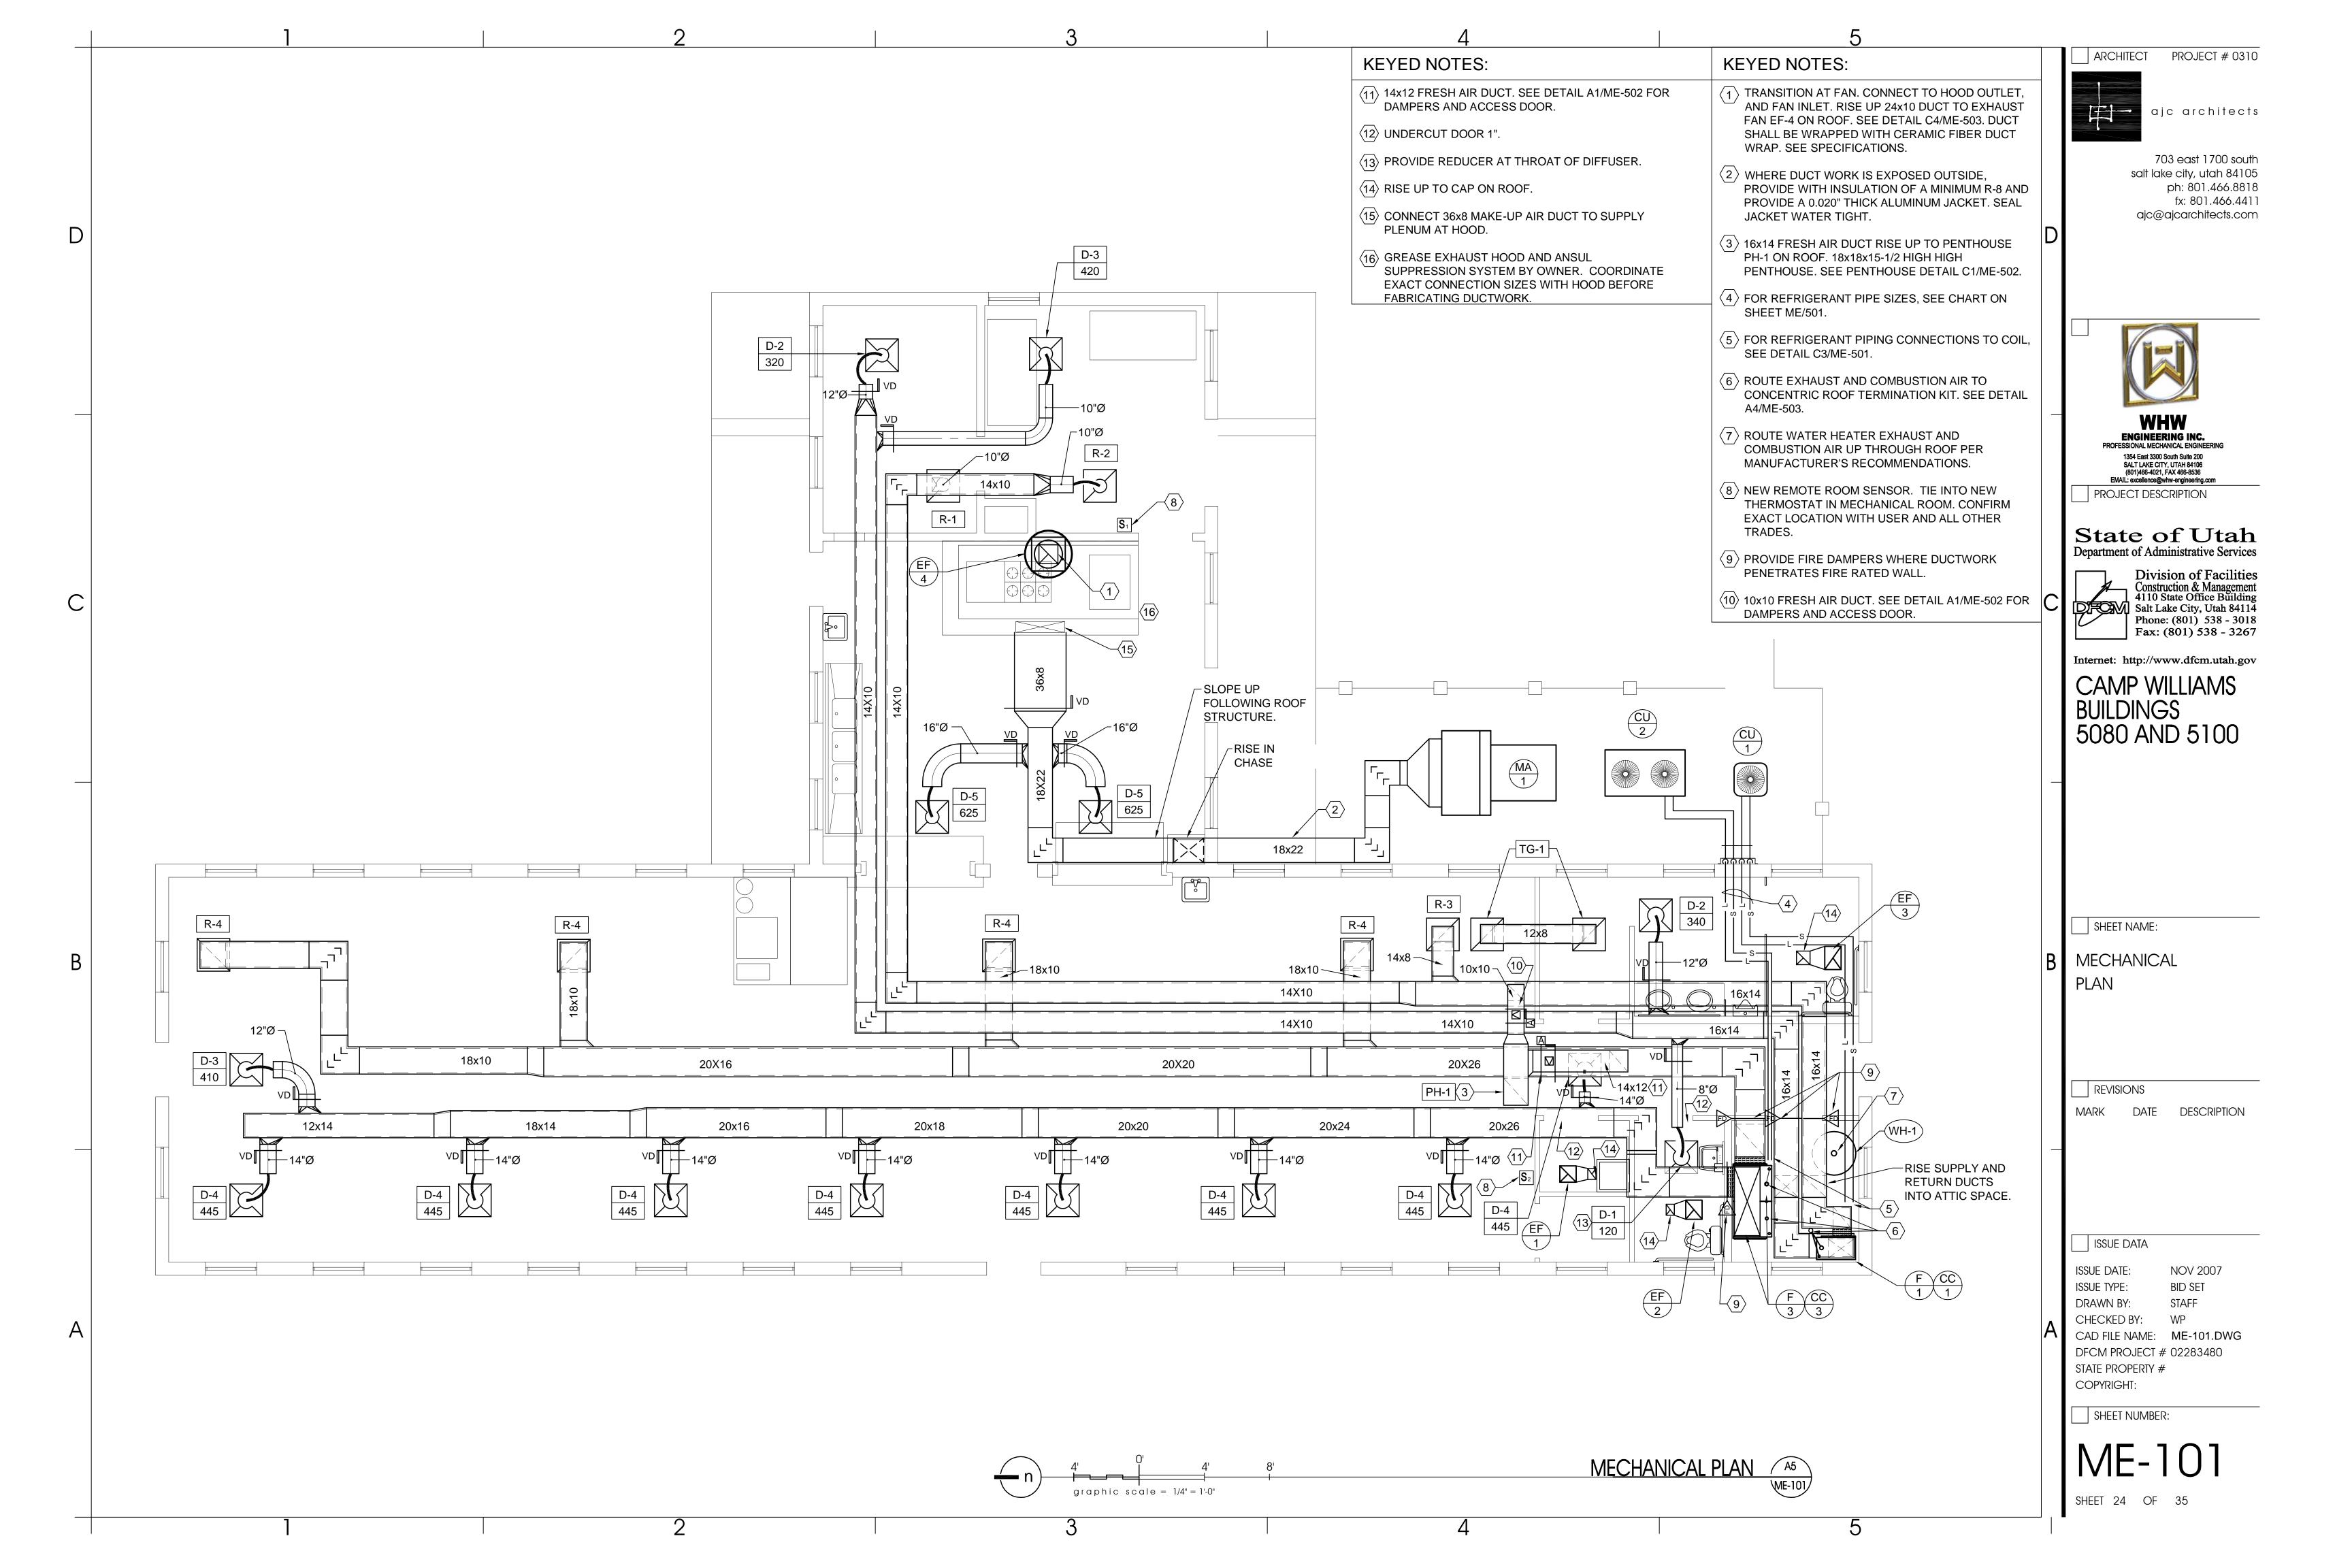

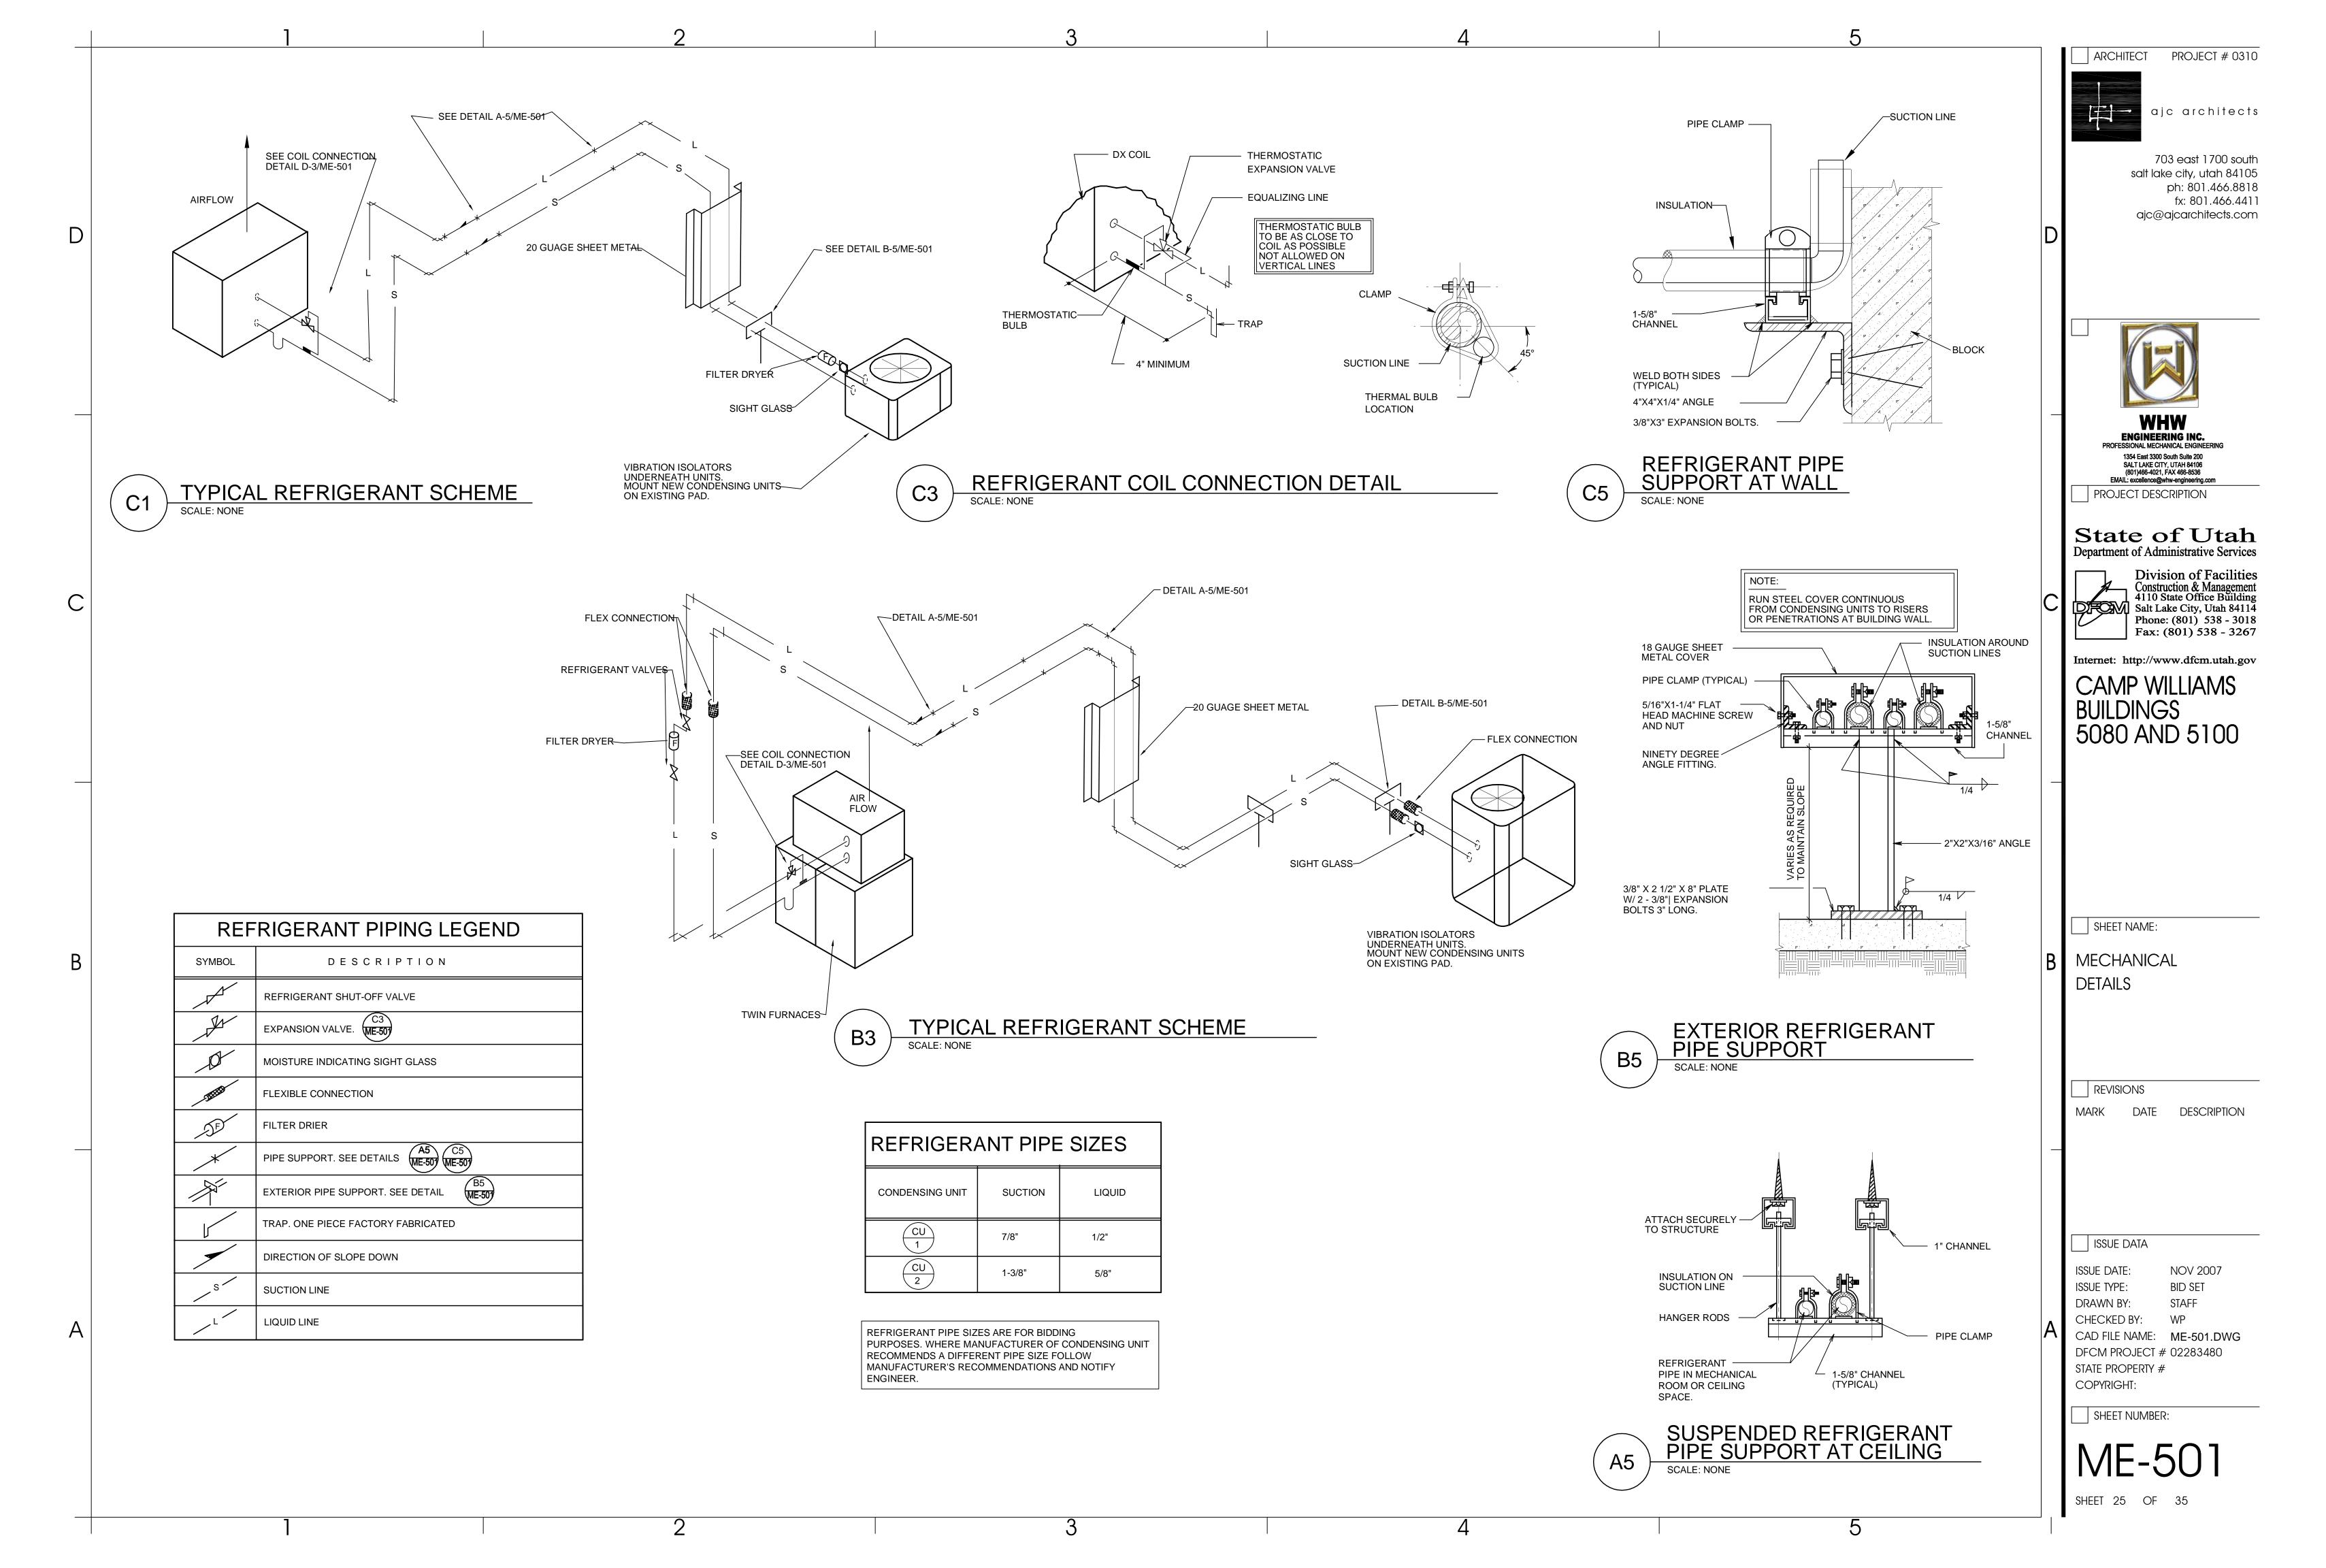

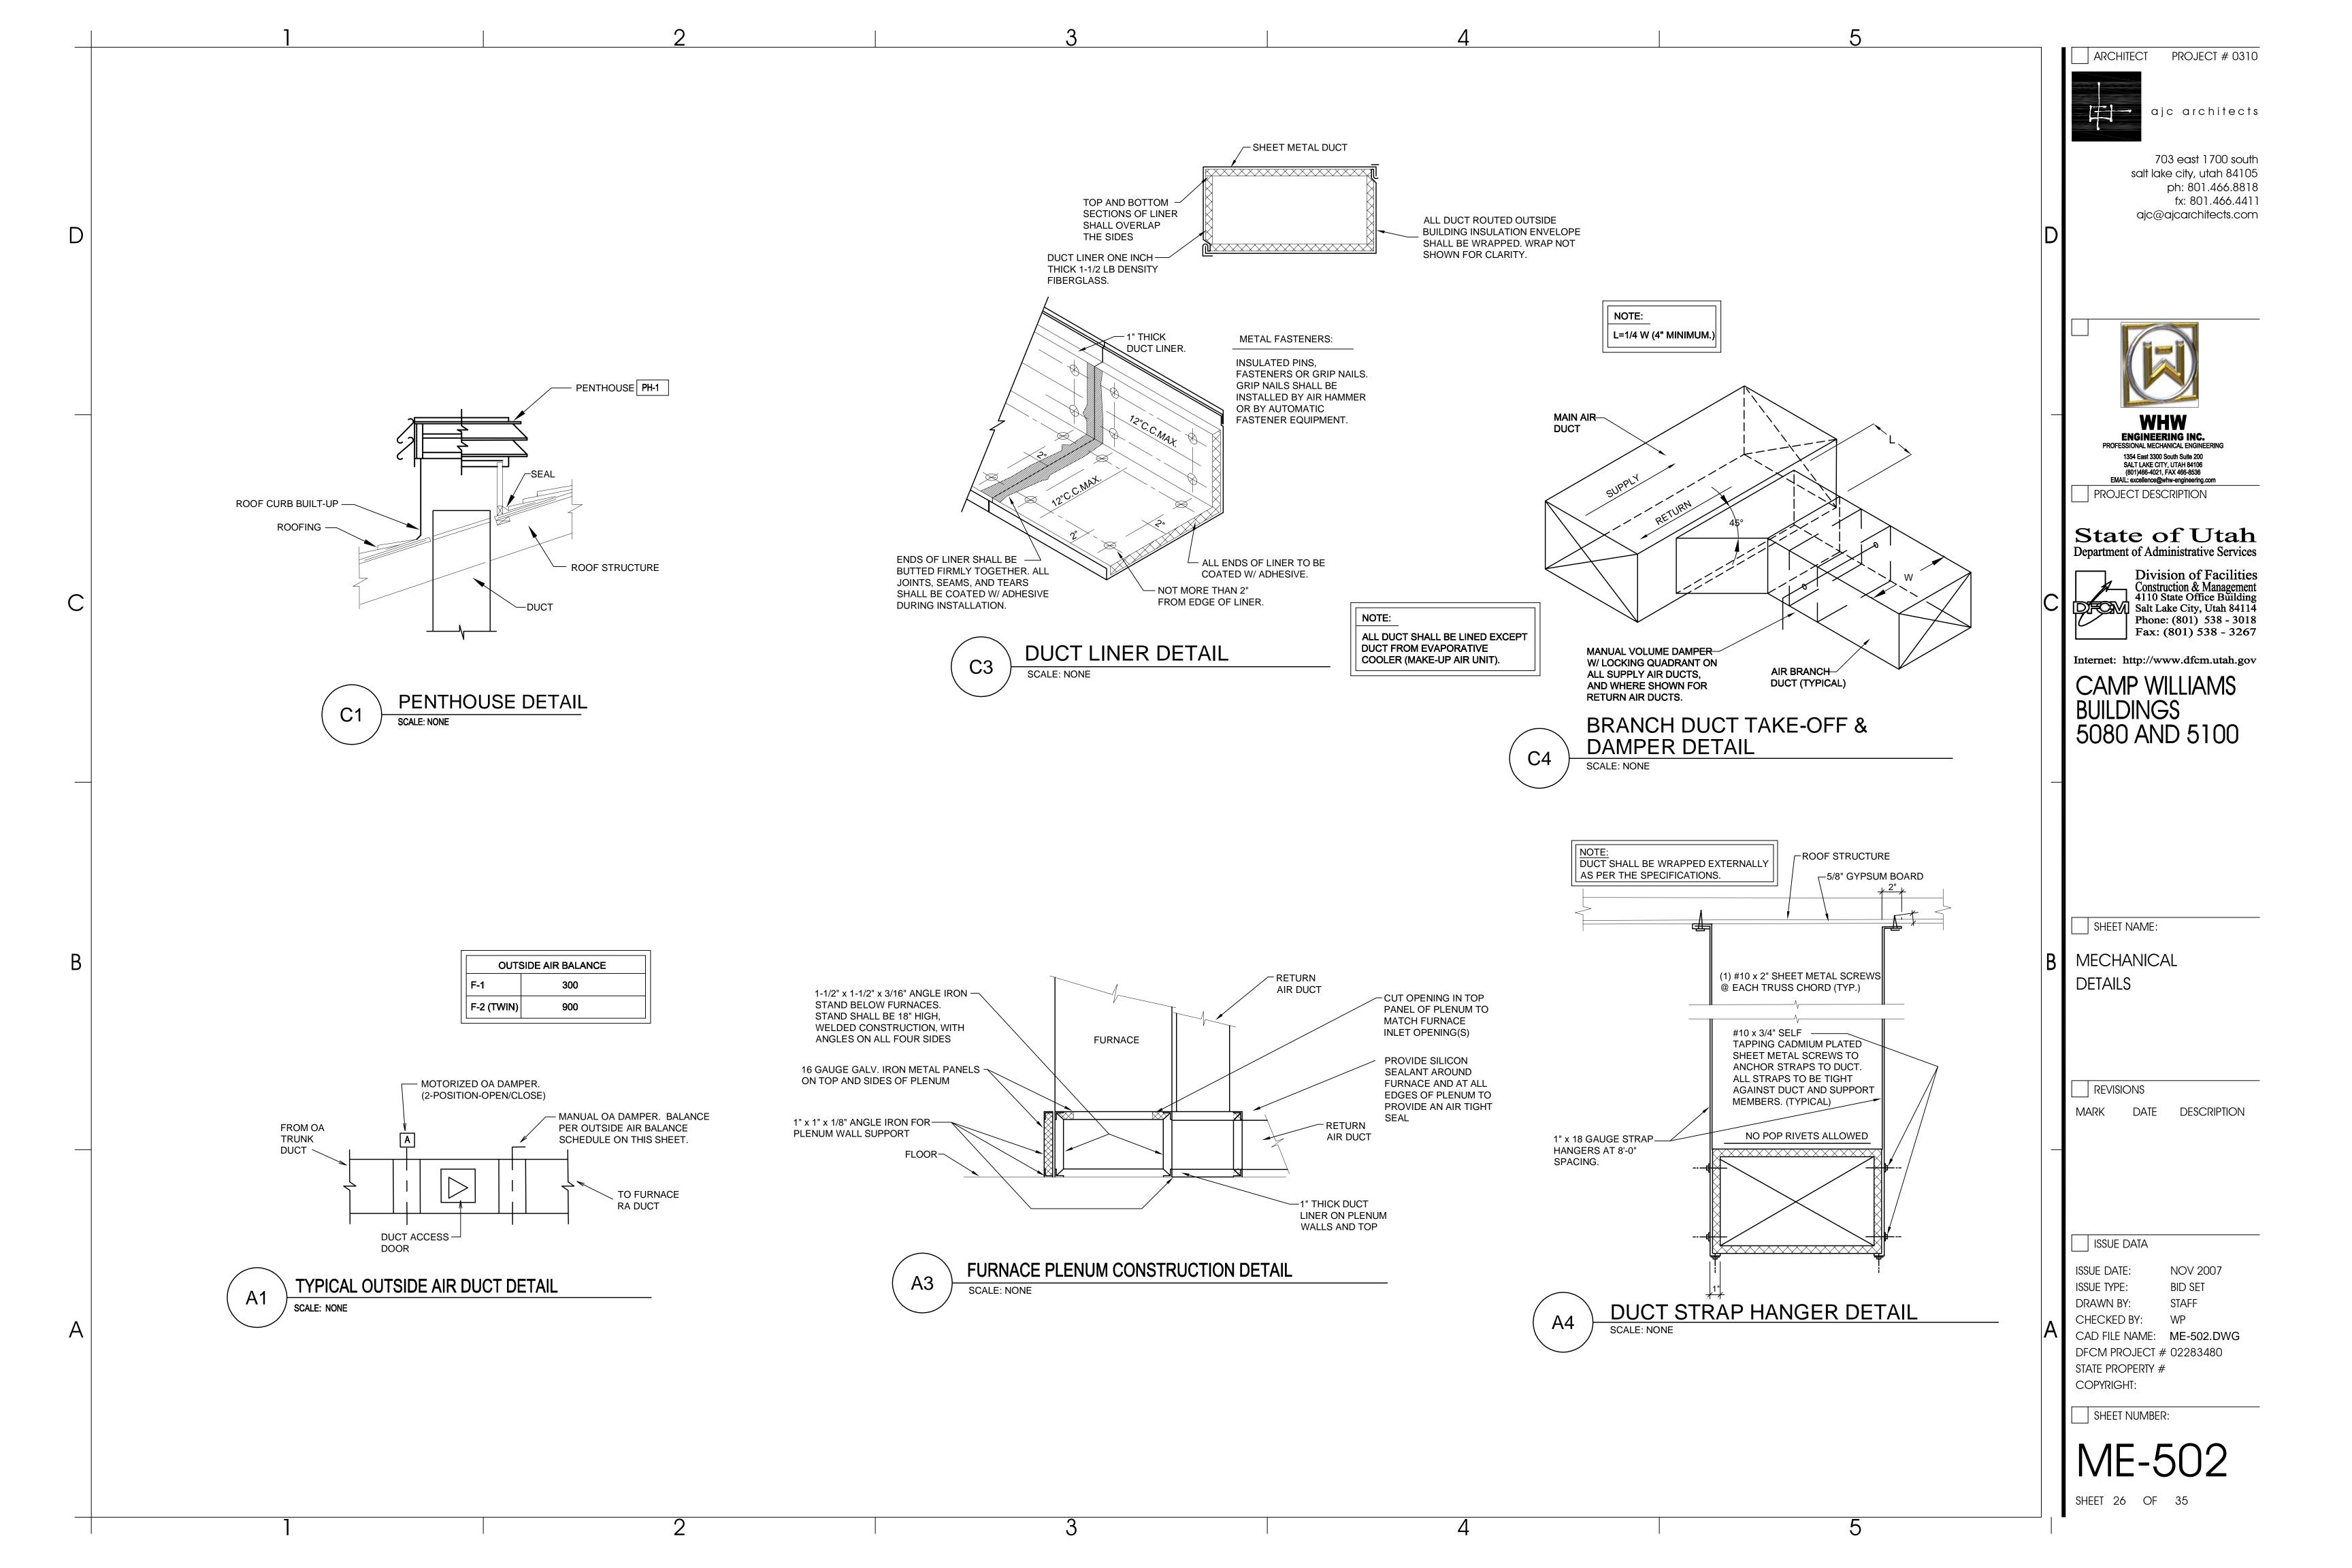

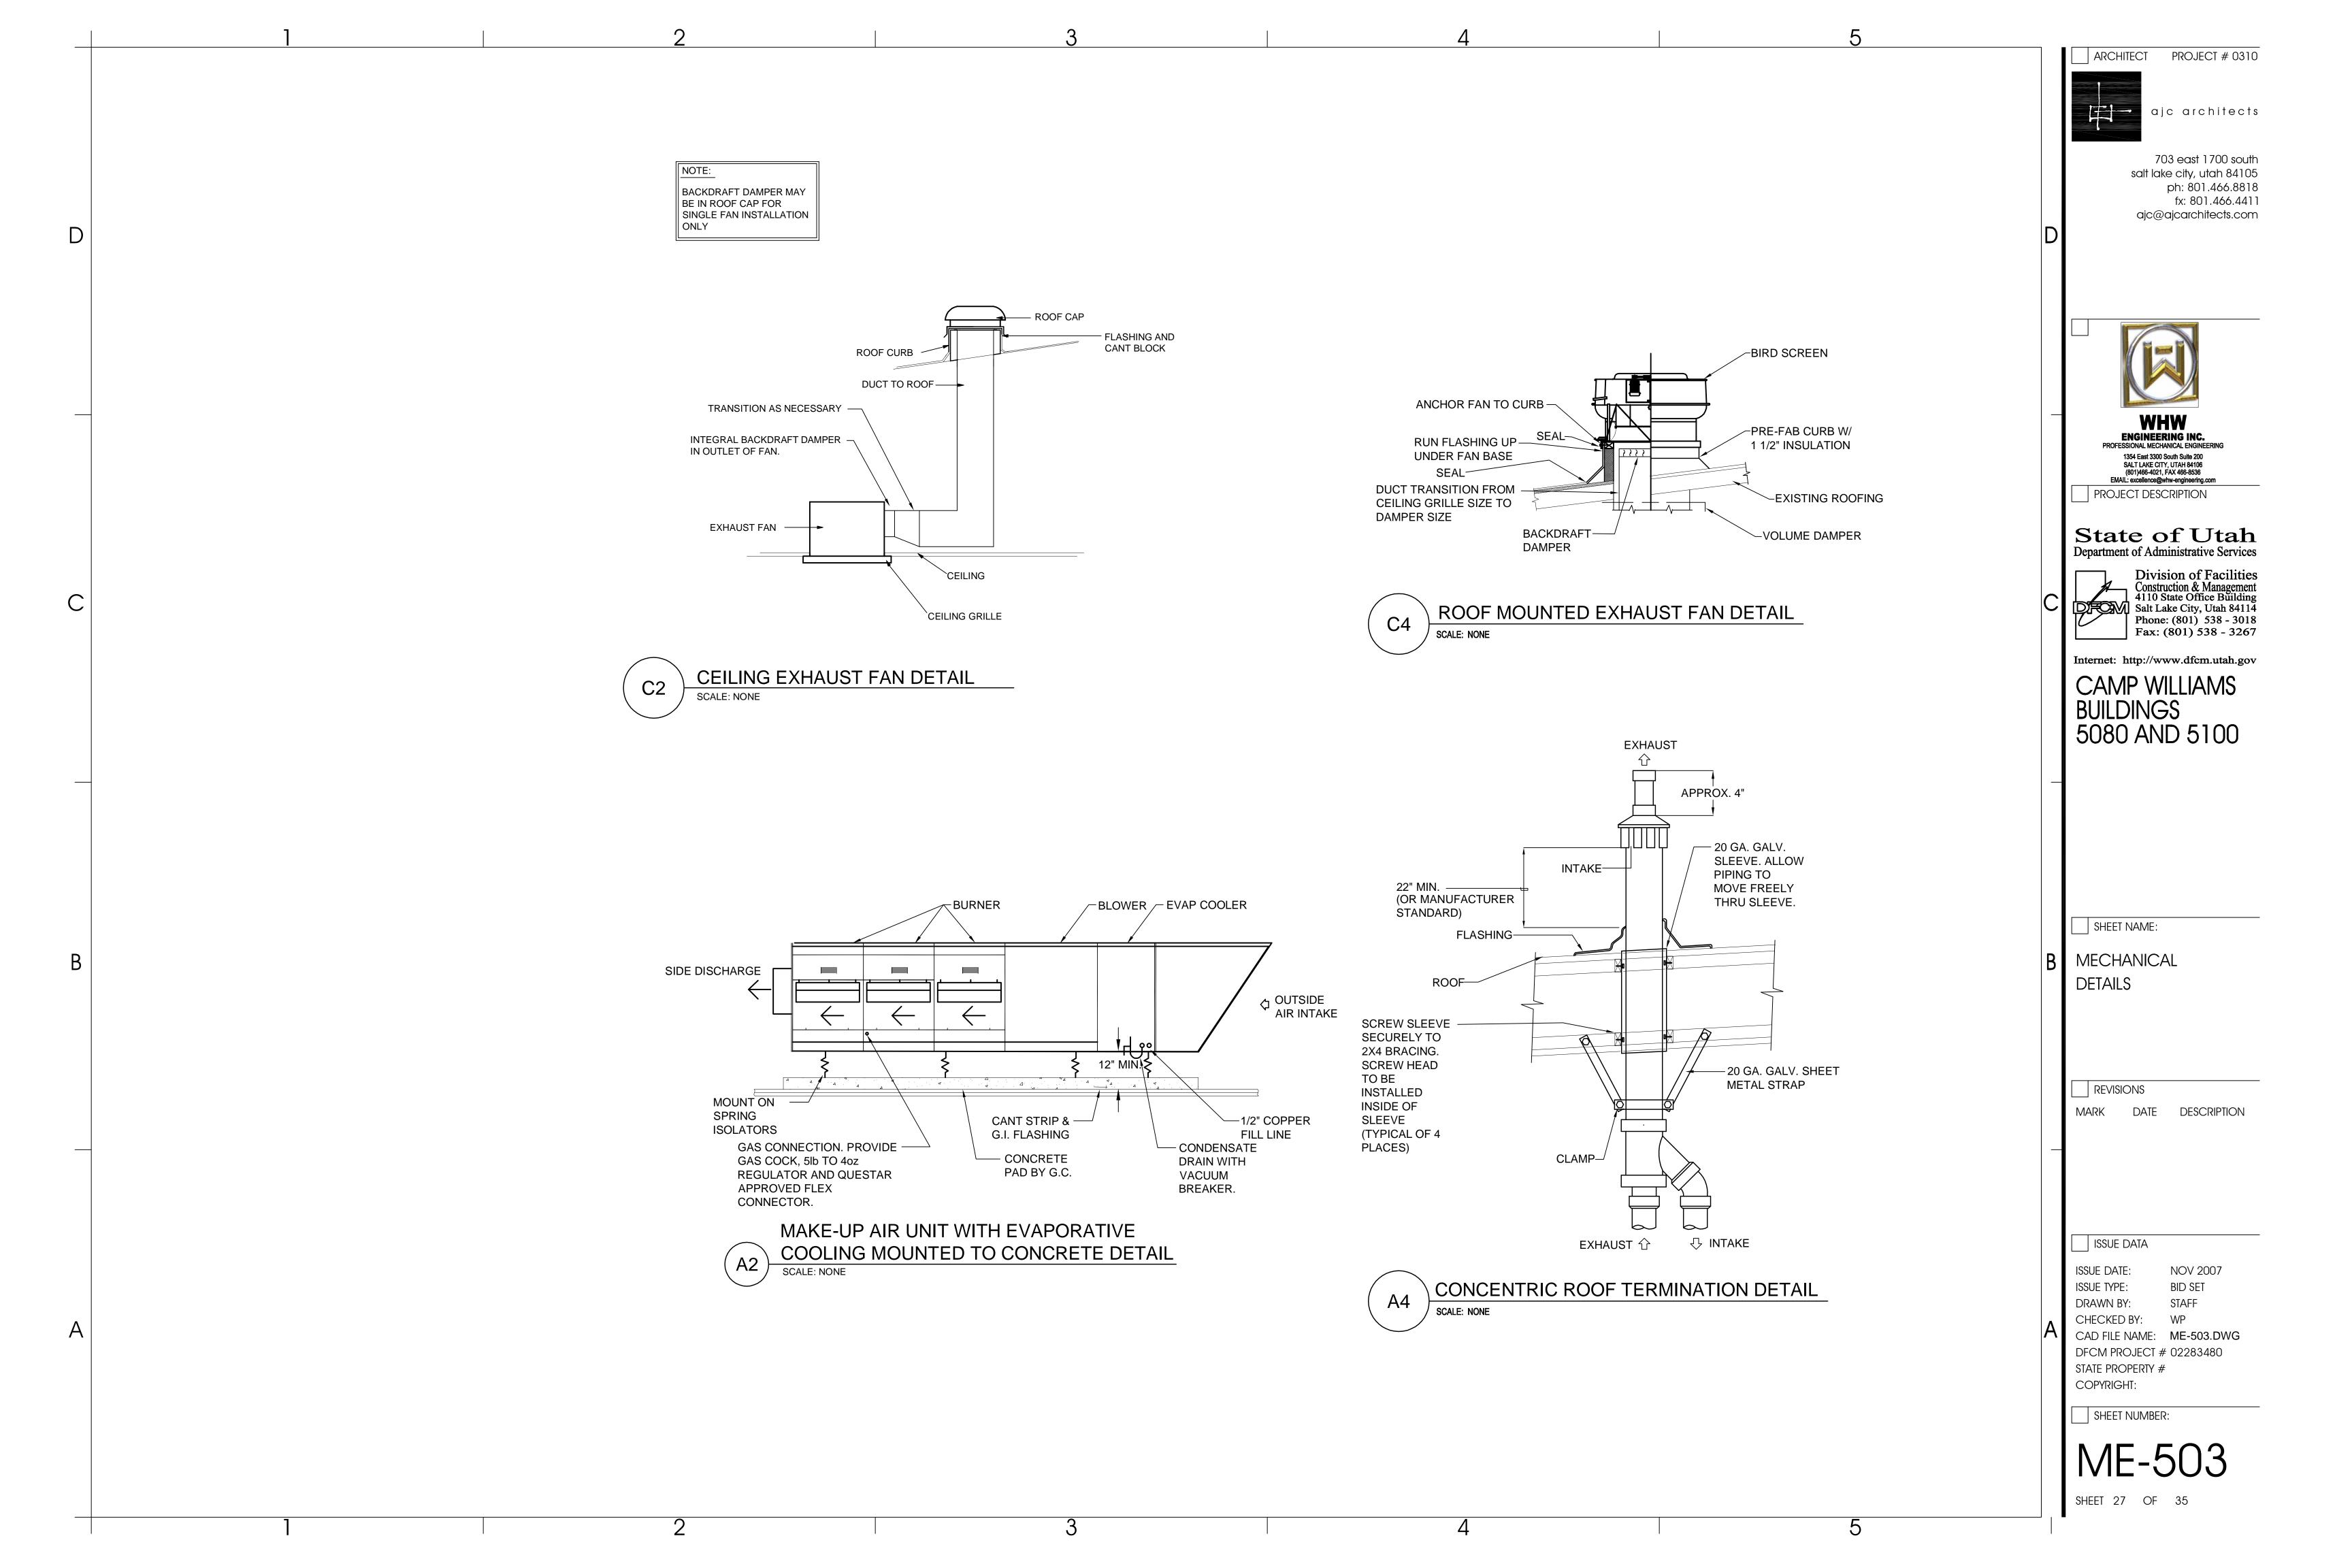

	EXHAUST FAN SCHEDULE												
SYMBOL	SYMBOL SERVES MIN. S.C.F.M. STATIC PRESSURE IN. W.G. V/Ø/Hz WEIGHT LBS. COMMENTS 2												
EF 1	JANITOR	50	0.25	35 WATTS 115/1Ø/60	13	COOK GC-120							
EF 2	WOMENS RESTROOM 115	140	0.25	90 WATTS 115/1Ø/60	17	COOK GC-160							
EF 3	MENS RESTROOM 117	350	0.25	184 WATTS 115/1Ø/60	35	COOK GC-620							
EF 4	KITCHEN GREASE HOOD	2500	1.25	1 HP 208/3Ø/60	123	COOK 180-VCR-HP 23							

DIFFUSER SCHEDULE 23 AIR DIST./SIDE NECK SIZE NOMINAL CEILING PATTERN SYMBOL **BLOW** COMMENTS SIZE MODULE B (%) A (%) D-1 LAY-IN TITUS TDC 4-WAY 25 25 9x9 120 6"Ø CFM D-2 TITUS TDC 25 25 LAY-IN 4-WAY 340 12"Ø 12x12 CFM D-3 4-WAY TITUS TDC LAY-IN 25 25 15x15 420 12"Ø CFM D-4 LAY-IN 25 25 4-WAY TITUS TDC 445 15x15 CFM 14"Ø D-5 TITUS TDC 38 3-WAY 31 LAY-IN 700 16"Ø 18x18 CFM

VERIFY MOTOR VOLTAGES WITH THE ELECTRICAL DRAWINGS BEFORE ORDERING MOTORIZED EQUIPMENT AND CONTROLS. MOTOR NAME PLATE VOLTAGE SHALL BE NEMA STANDARD 200 VOLT, FOR 208 VOLT, THREE PHASE SYSTEM AND SHALL BE NEMA STANDARD 230 VOLT FOR 240 VOLT THREE PHASE OR SINGLE PHASE SYSTEM. STARTER HEATERS INSTALLED SHALL BE COORDINATED WITH THE NAME PLATE DATA.

- SEE SPECIFICATIONS FOR CONTROLS.
- (3) INTERLOCK WITH MAKE-UP AIR UNIT MA-1.

	MAKE-UP AIR UNIT SCHEDULE 123													
SYMBOL	OUTPUT MBH	CFM	F.S.P. IN. W.C.	ENT. AIR TEMP.	AIR TEMP. RISE	VOLT	MO ⁻ Hz	TOR Ø	HP	MANUFACTURER & MODEL NUMBER				
MA 1	240	2500	0.75	0	77	208	60	3	1.5	ARES MODEL 300				

- 1 CONDITIONS AT SEA LEVEL
- ② WITH EVAPORATIVE COOLING
- ③ INTERLOCK WITH EXHAUST FAN EF-4.

	AIR COOLED CONDENSING UNIT SCHEDULE												
0.445.01	MIN SIZE			SEER /		14000	MANUF. &	SCHEDULE					
SYMBOL	MBOL (TONS)		LRA (EACH)	EER	MCA	MOCP	MODEL#	NOTES					
CU 1	3	10	88	13 SEER	13.9	20	CARRIER 24ABR 036	1,2,3,4,5					
CU 2	10	37.8	239	10.4 EER	50.3	60	CARRIER 38ARZ 012	1,2,3,4,5					

- . REFRIGERANT PURON.
- 2. AT DESIGN CONDITIONS AND 95° F EAT.
- 3. CONDENSING UNIT SYMBOLS CORRESPOND WITH FURNACE SYMBOLS, EXCEPT AS NOTED.
- 4. SEE SPECIFICATIONS FOR APPROVED MANUFACTURERS.
- 5. ELECTRIC SERVICE: 208/3Ø/60HZ

REGISTER, LOUVER & GRILLE SCHEDULE													
TYPE	SERVICE	MAX CFM (1)	NOMINAL SIZE	THROAT SIZE	CEILING MODULE	COMMENTS 26							
CEILING	RA	320	12x12	10"Ø	LAY-IN	TITUS 355Z 8 (3							
CEILING	RA	420	12x12	12"Ø	LAY-IN	TITUS 355Z							
CEILING	RA	460	14x14	14x8	LAY-IN	TITUS 355Z 8 (3							
CEILING	RA	1000	18x18	18x10	LAY-IN	TITUS 355Z							
CEILING	T.A.	320	12x12	12x8	LAY-IN	TITUS 355Z							
PENTHOUSE	F.A.	2.2 sq. ft. FREE AREA	18x18x15.5	NA	NA	- 456							
	TYPE CEILING CEILING CEILING CEILING CEILING	TYPE SERVICE CEILING RA CEILING RA CEILING RA CEILING RA CEILING T.A.	TYPE SERVICE MAX CFM 1 CEILING RA 320 CEILING RA 420 CEILING RA 460 CEILING RA 1000 CEILING T.A. 320 PENTHOUSE F.A. 2.2 sq. ft.	TYPE SERVICE MAX CFM (1) NOMINAL SIZE CEILING RA 320 12x12 CEILING RA 420 12x12 CEILING RA 460 14x14 CEILING RA 1000 18x18 CEILING T.A. 320 12x12 PENTHOUSE F.A. 2.2 sq. ft. 18x18x15.5	TYPE SERVICE MAX CFM (1) NOMINAL SIZE THROAT SIZE CEILING RA 320 12x12 10"Ø CEILING RA 420 12x12 12"Ø CEILING RA 460 14x14 14x8 CEILING RA 1000 18x18 18x10 CEILING T.A. 320 12x12 12x8 PENTHOUSE F.A. 2.2 sq. ft. 18x18x15.5 NA	TYPE SERVICE MAX CFM (1) NOMINAL SIZE THROAT SIZE CEILING MODULE CEILING RA 320 12x12 10"Ø LAY-IN 7 CEILING RA 420 12x12 12"Ø LAY-IN 7 CEILING RA 460 14x14 14x8 LAY-IN 7 CEILING RA 1000 18x18 18x10 LAY-IN 7 CEILING T.A. 320 12x12 12x8 LAY-IN 7 PENTHOUSE F.A 2.2 sq. ft. 18x18x15.5 NA NA							

REGISTER, LOUVER AND DIFFUSER SCHEDULE NOTES:


- 1) MAXIMUM NC=20 @ MAXIMUM CFM NOTED.
- ② MODEL NUMBERS LISTED ARE TITUS. SEE SPECIFICATIONS FOR OTHER APPROVED MANUFACTURERS.
- (3) FINISH SHALL BE STANDARD WHITE BAKED ENAMEL.
- 4 BAKED ENAMEL FINISH WITH COLOR AS DIRECTED BY ARCHITECT.
- 5 PROVIDE ALUMINUM BIRD SCREENS.
- 6 FOR APPROVED MANUFACTURERS AND MODEL NUMBERS SEE SPECIFICATIONS.
- (7) CEILING MODULE SIZE FOR LAY-IN CEILING IS 24x24.
- 8 FRAME SHALL BE SIMILAR TO TITUS #3 FRAME.

	COOLING COIL SCHEDULE												
	MIN. RE CAPA		COND. EN	NT. EVAP.			SCHEDULE						
SYMBOL	ТОТ. МВН	SEN. MBH	DB °F	WB °F	CFM	MODEL#	NOTES						
	42	32	95	65	1200	CK5A036	1,2,3						
CC 2	63	49	95	65	1995	CNRVP6024	1,2,3						
<u>CC</u> 3	63	49	95	65	1995	CNRVP6024	1,2,3						

- 1. COMPLETE WITH FACTORY COIL BOX AND COIL.
- 2. MANUFACTURER NUMBER LISTED ARE CARRIER.
- 3. CAPACITIES SHOWN ARE FOR SINGLE COILS.

		FURNACE SCHEDULE													
SYMBOL	MIN. REQUIRED INPUT BTU/HR 1ST STAGE / 2ND	COOLING C.F.M.	HEATING C.F.M.	EXT. STATIC PRESSURE		MOTOR		MANUF. & MODEL #	SCHEDULE NOTES						
		STAGE	C.I .IVI.	C.I .IVI.	IN W.G.	V - Ø - Hz	MIN. HP	SPEED	WODEL#						
	F 1	52,000 / 80,000	1200	1200	.8	115-1-60	1/2	VARIABLE	CARRIER 58MVP80-14	1,2,3,4,5					
	F 2	78,000 / 120,000	1995 1885		.8	115-1-60	1	VARIABLE	CARRIER 58MVP120-20	1,2,3,4,5,6					
	F 3	78,000 / 120,000	1995	1885	.8	115-1-60	1	VARIABLE	CARRIER 58MVP120-20	1,2,3,4,5,6					

- 1. SEA LEVEL RATING.
- 2. FURNACE SYMBOLS CORRESPOND WITH CONDENSING UNIT AND COOLING COIL SYMBOLS.
- 3. SEE SPECIFICATIONS FOR APPROVED MANUFACTURERS.
- 4. PROVIDE CONCENTRIC VENT KIT.
- 5. MAY VARY ACCORDING TO MANUFACTURER.
- 6. PROVIDE TWINING KIT.

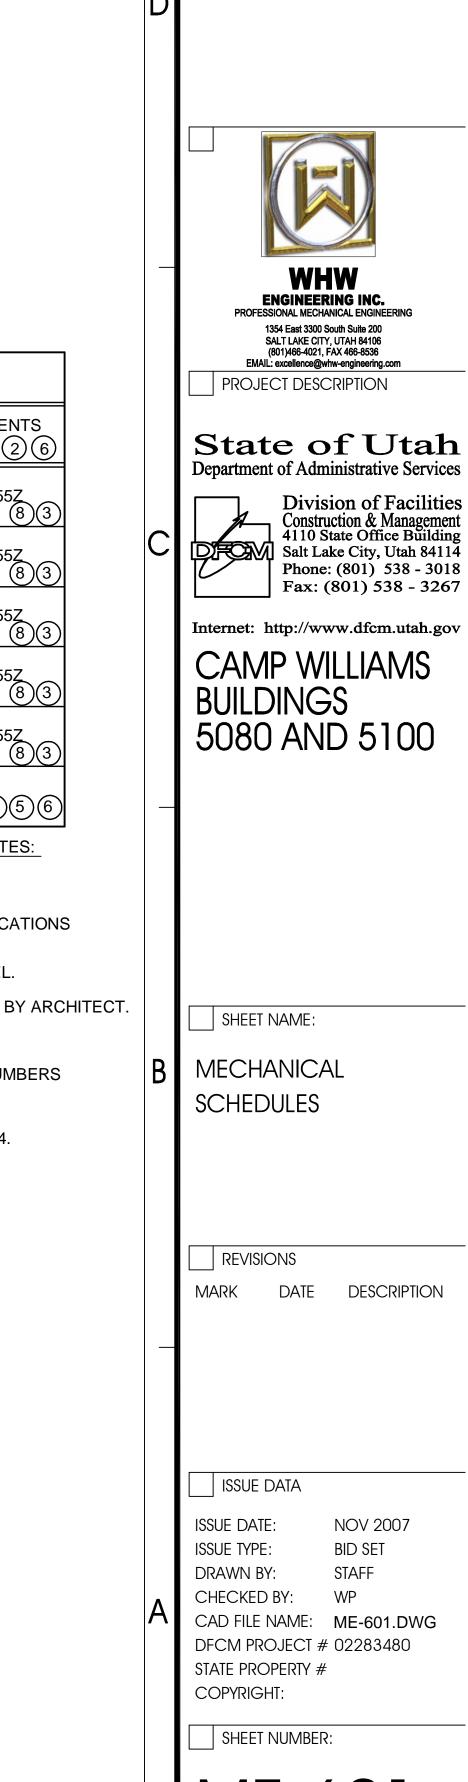

SHEET 28 OF 35

ARCHITECT PROJECT # 0310

ajc architects


703 east 1700 south


ph: 801.466.8818


fx: 801.466.4411


salt lake city, utah 84105


ajc@ajcarchitects.com

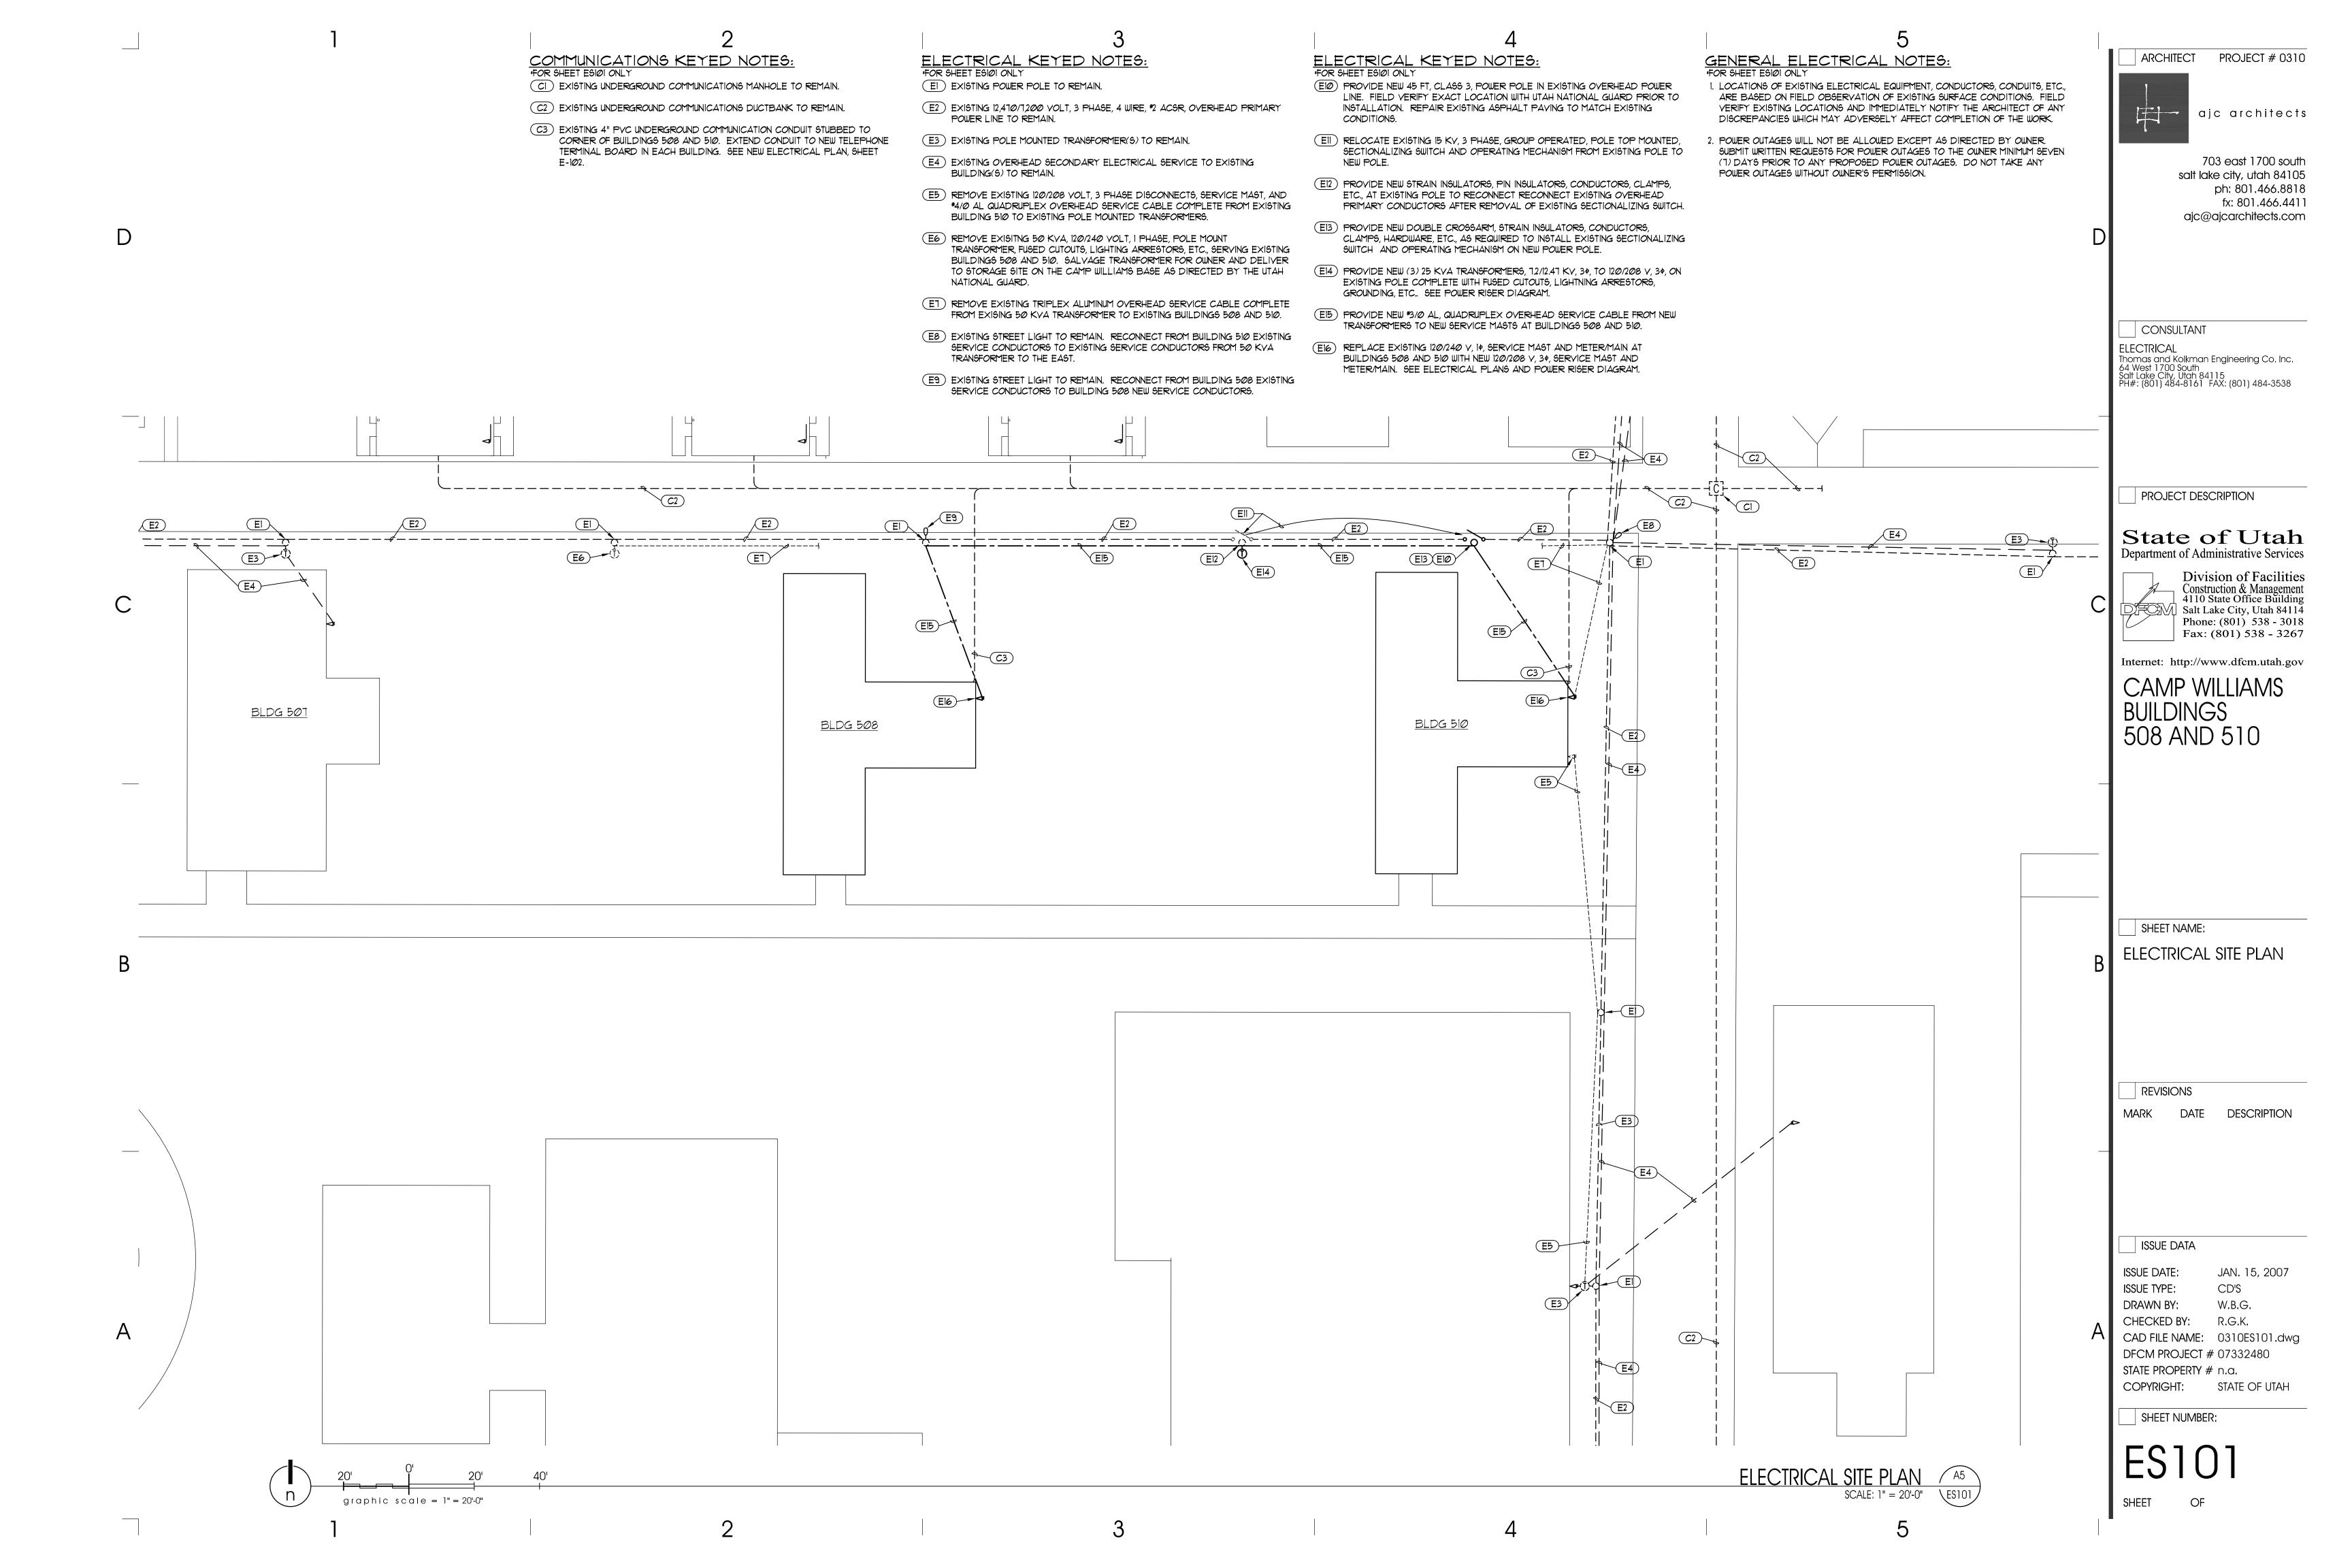

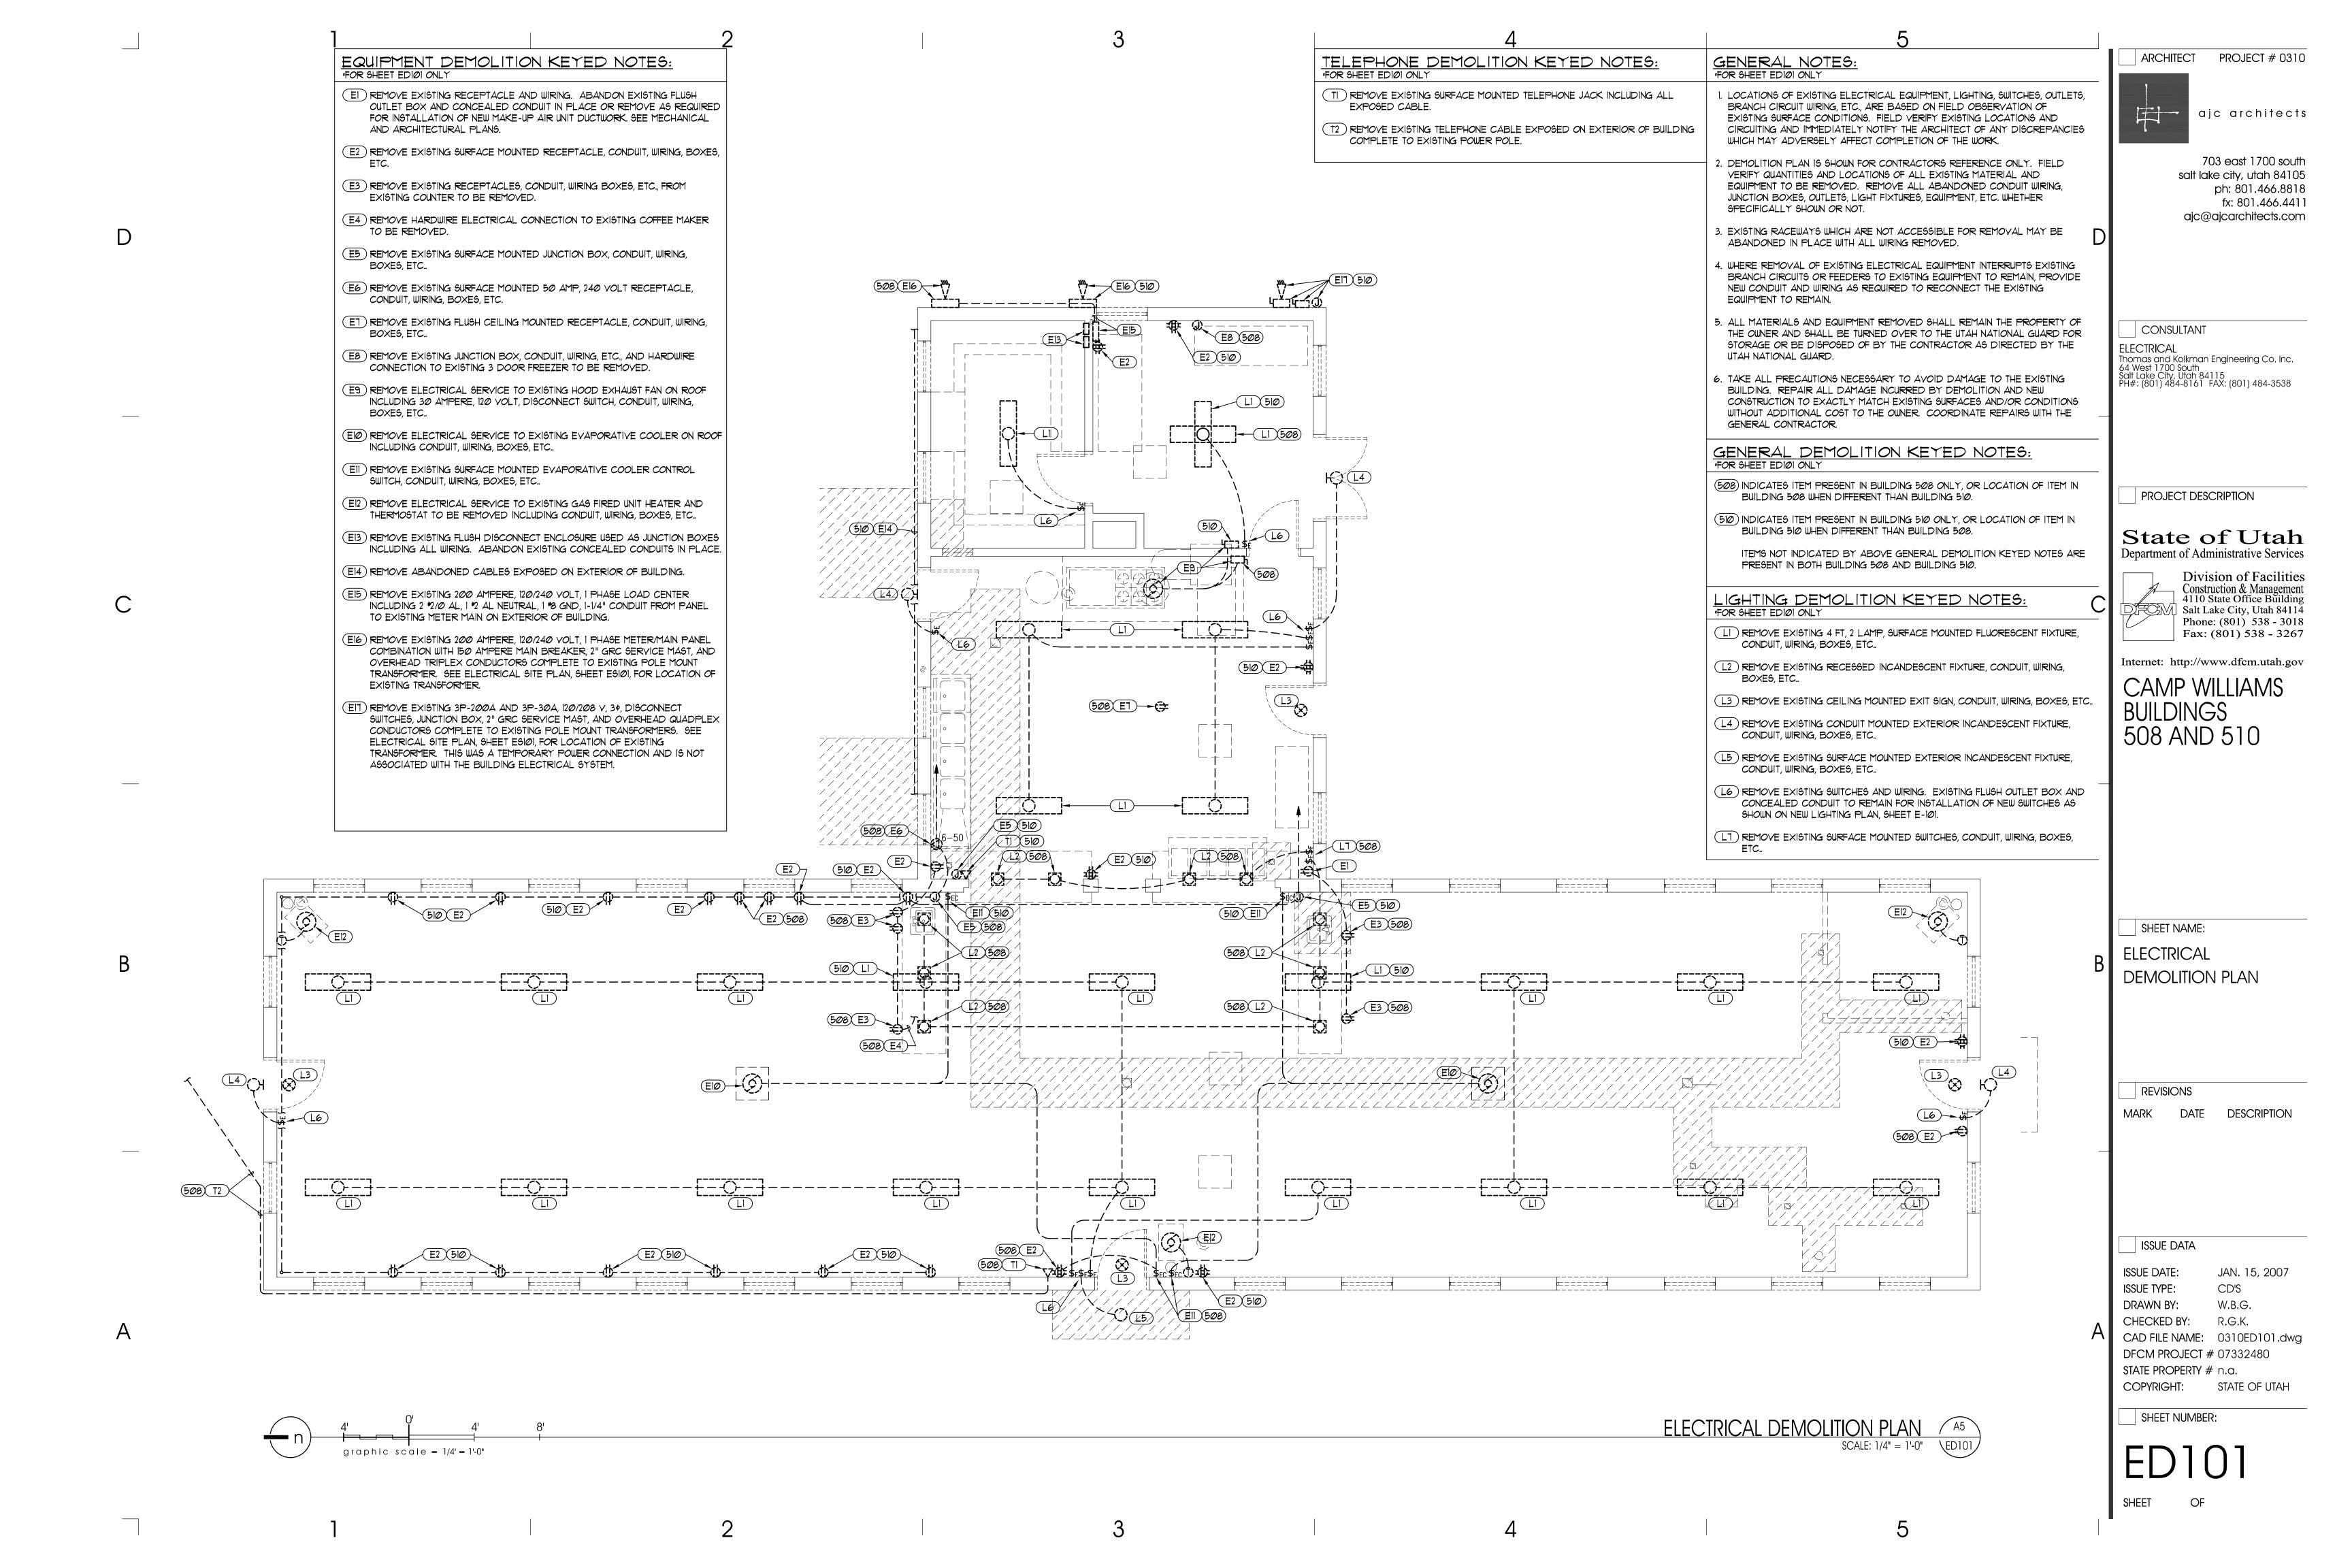

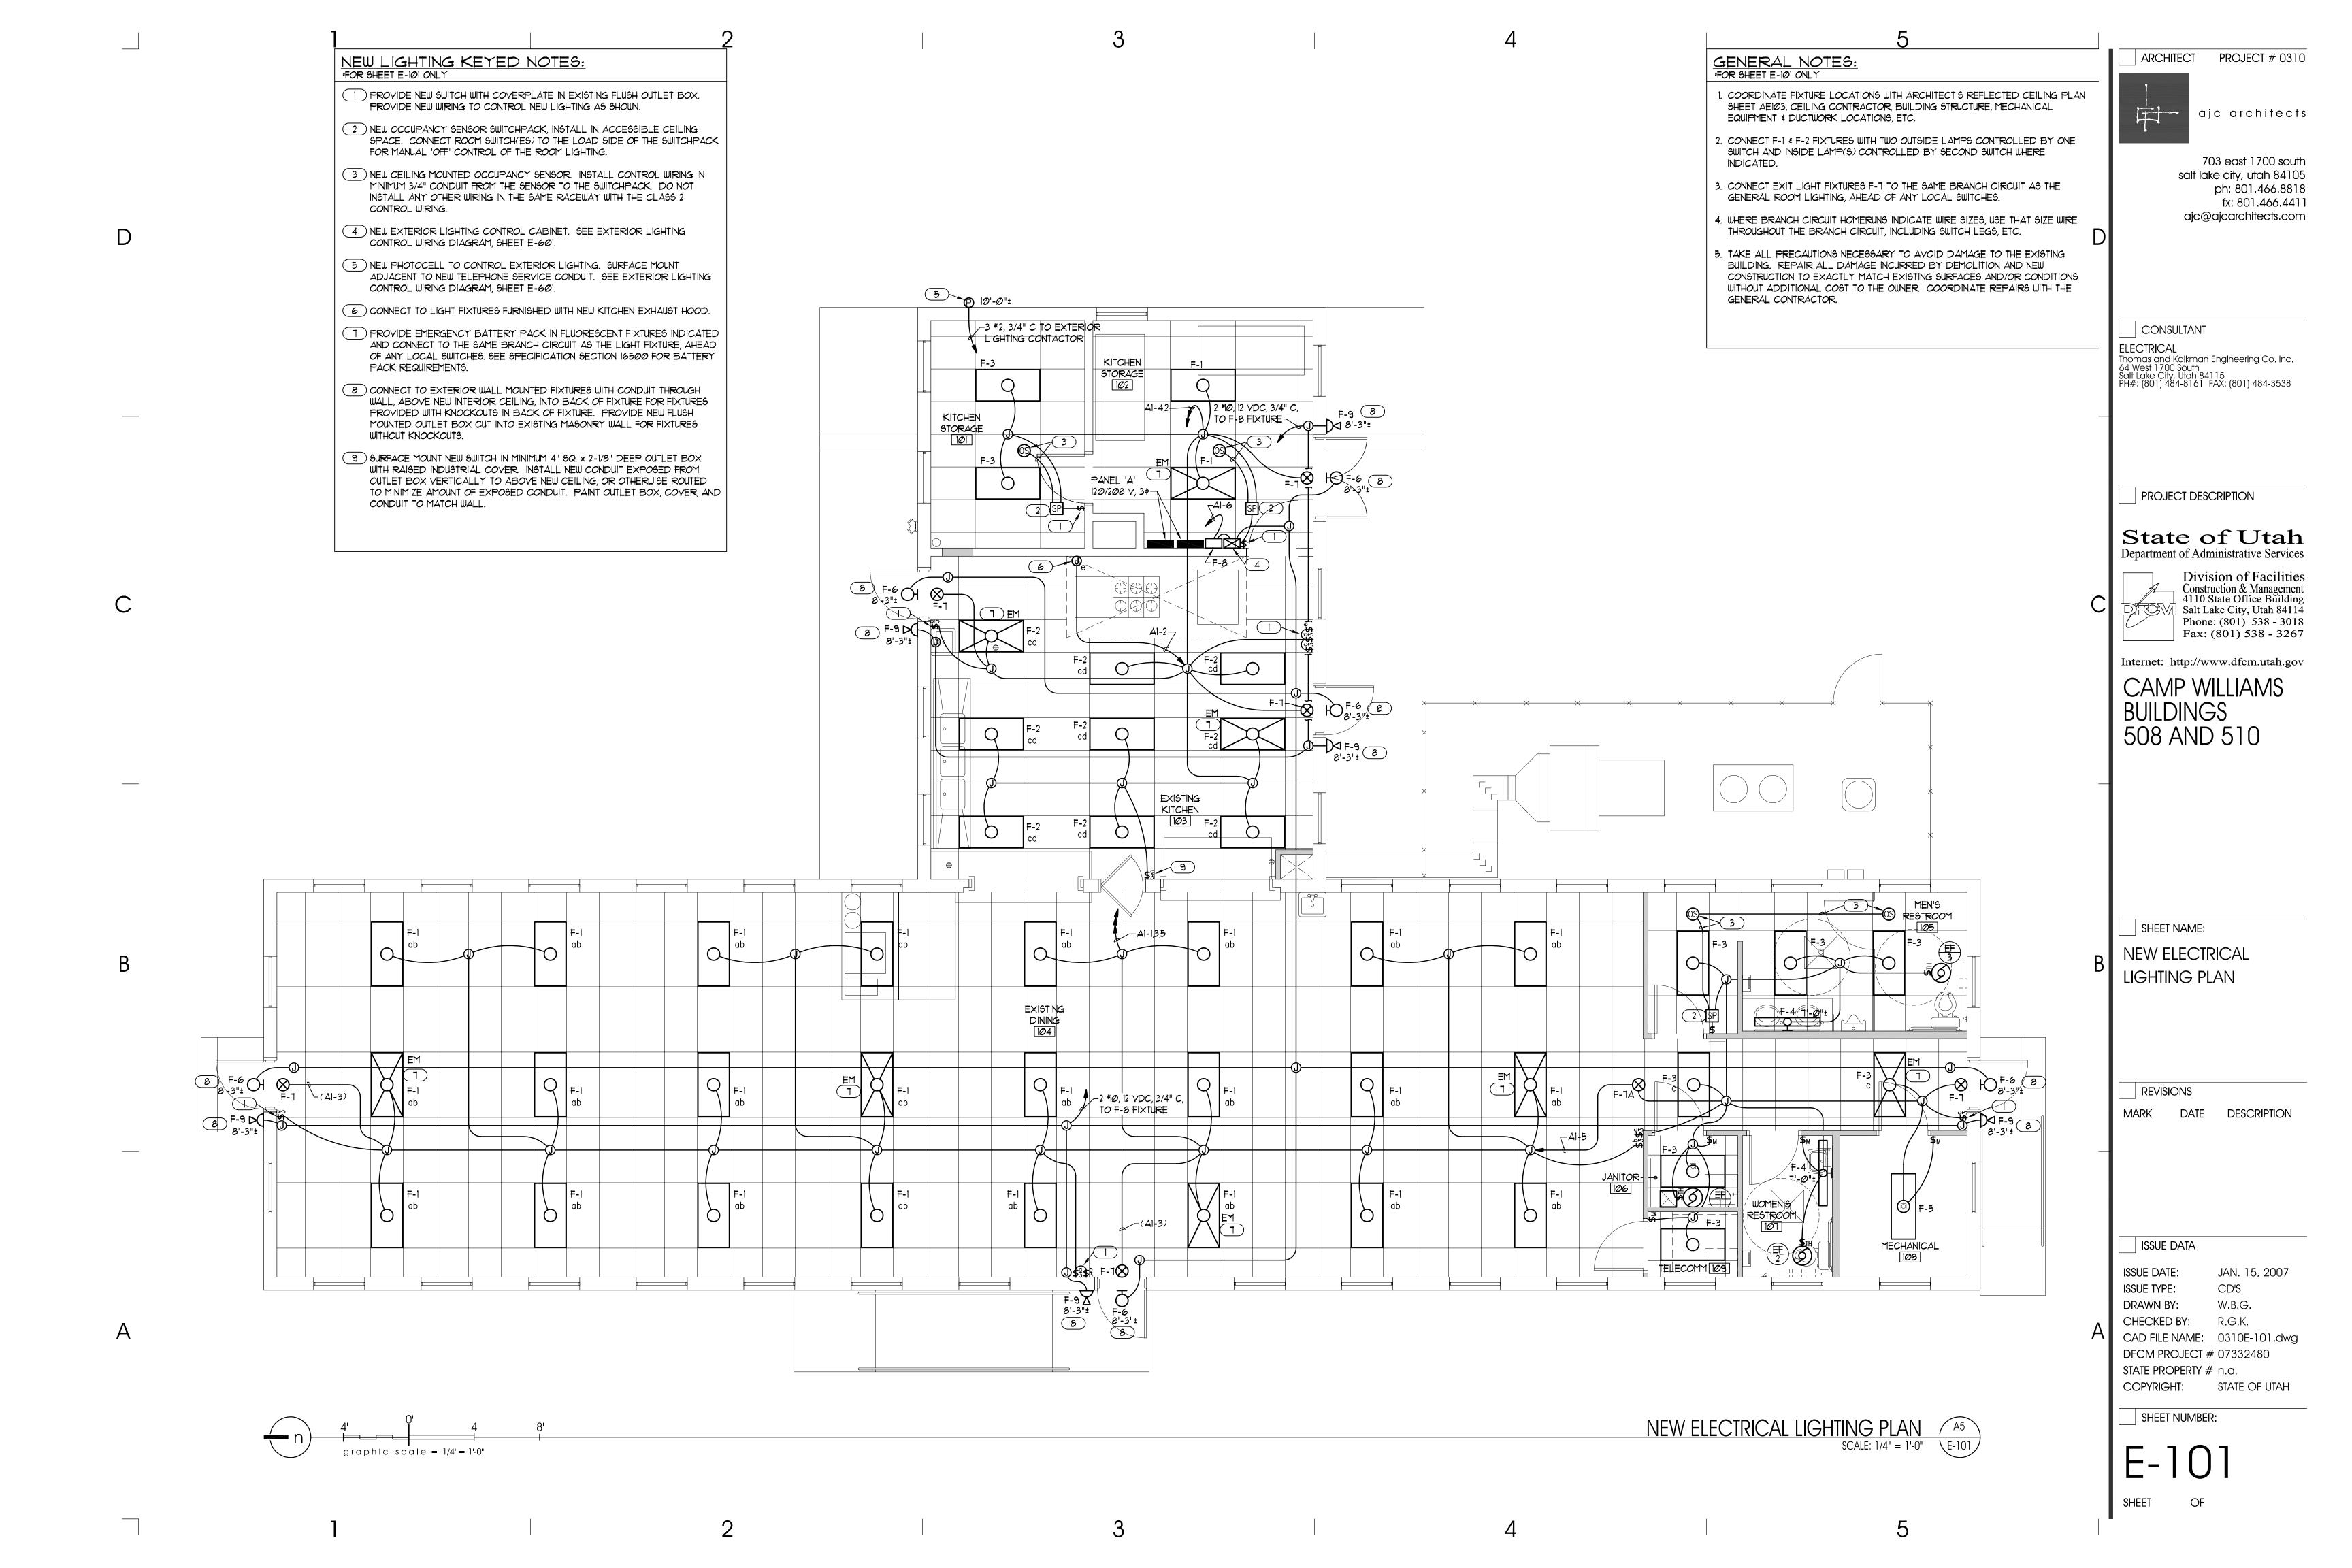

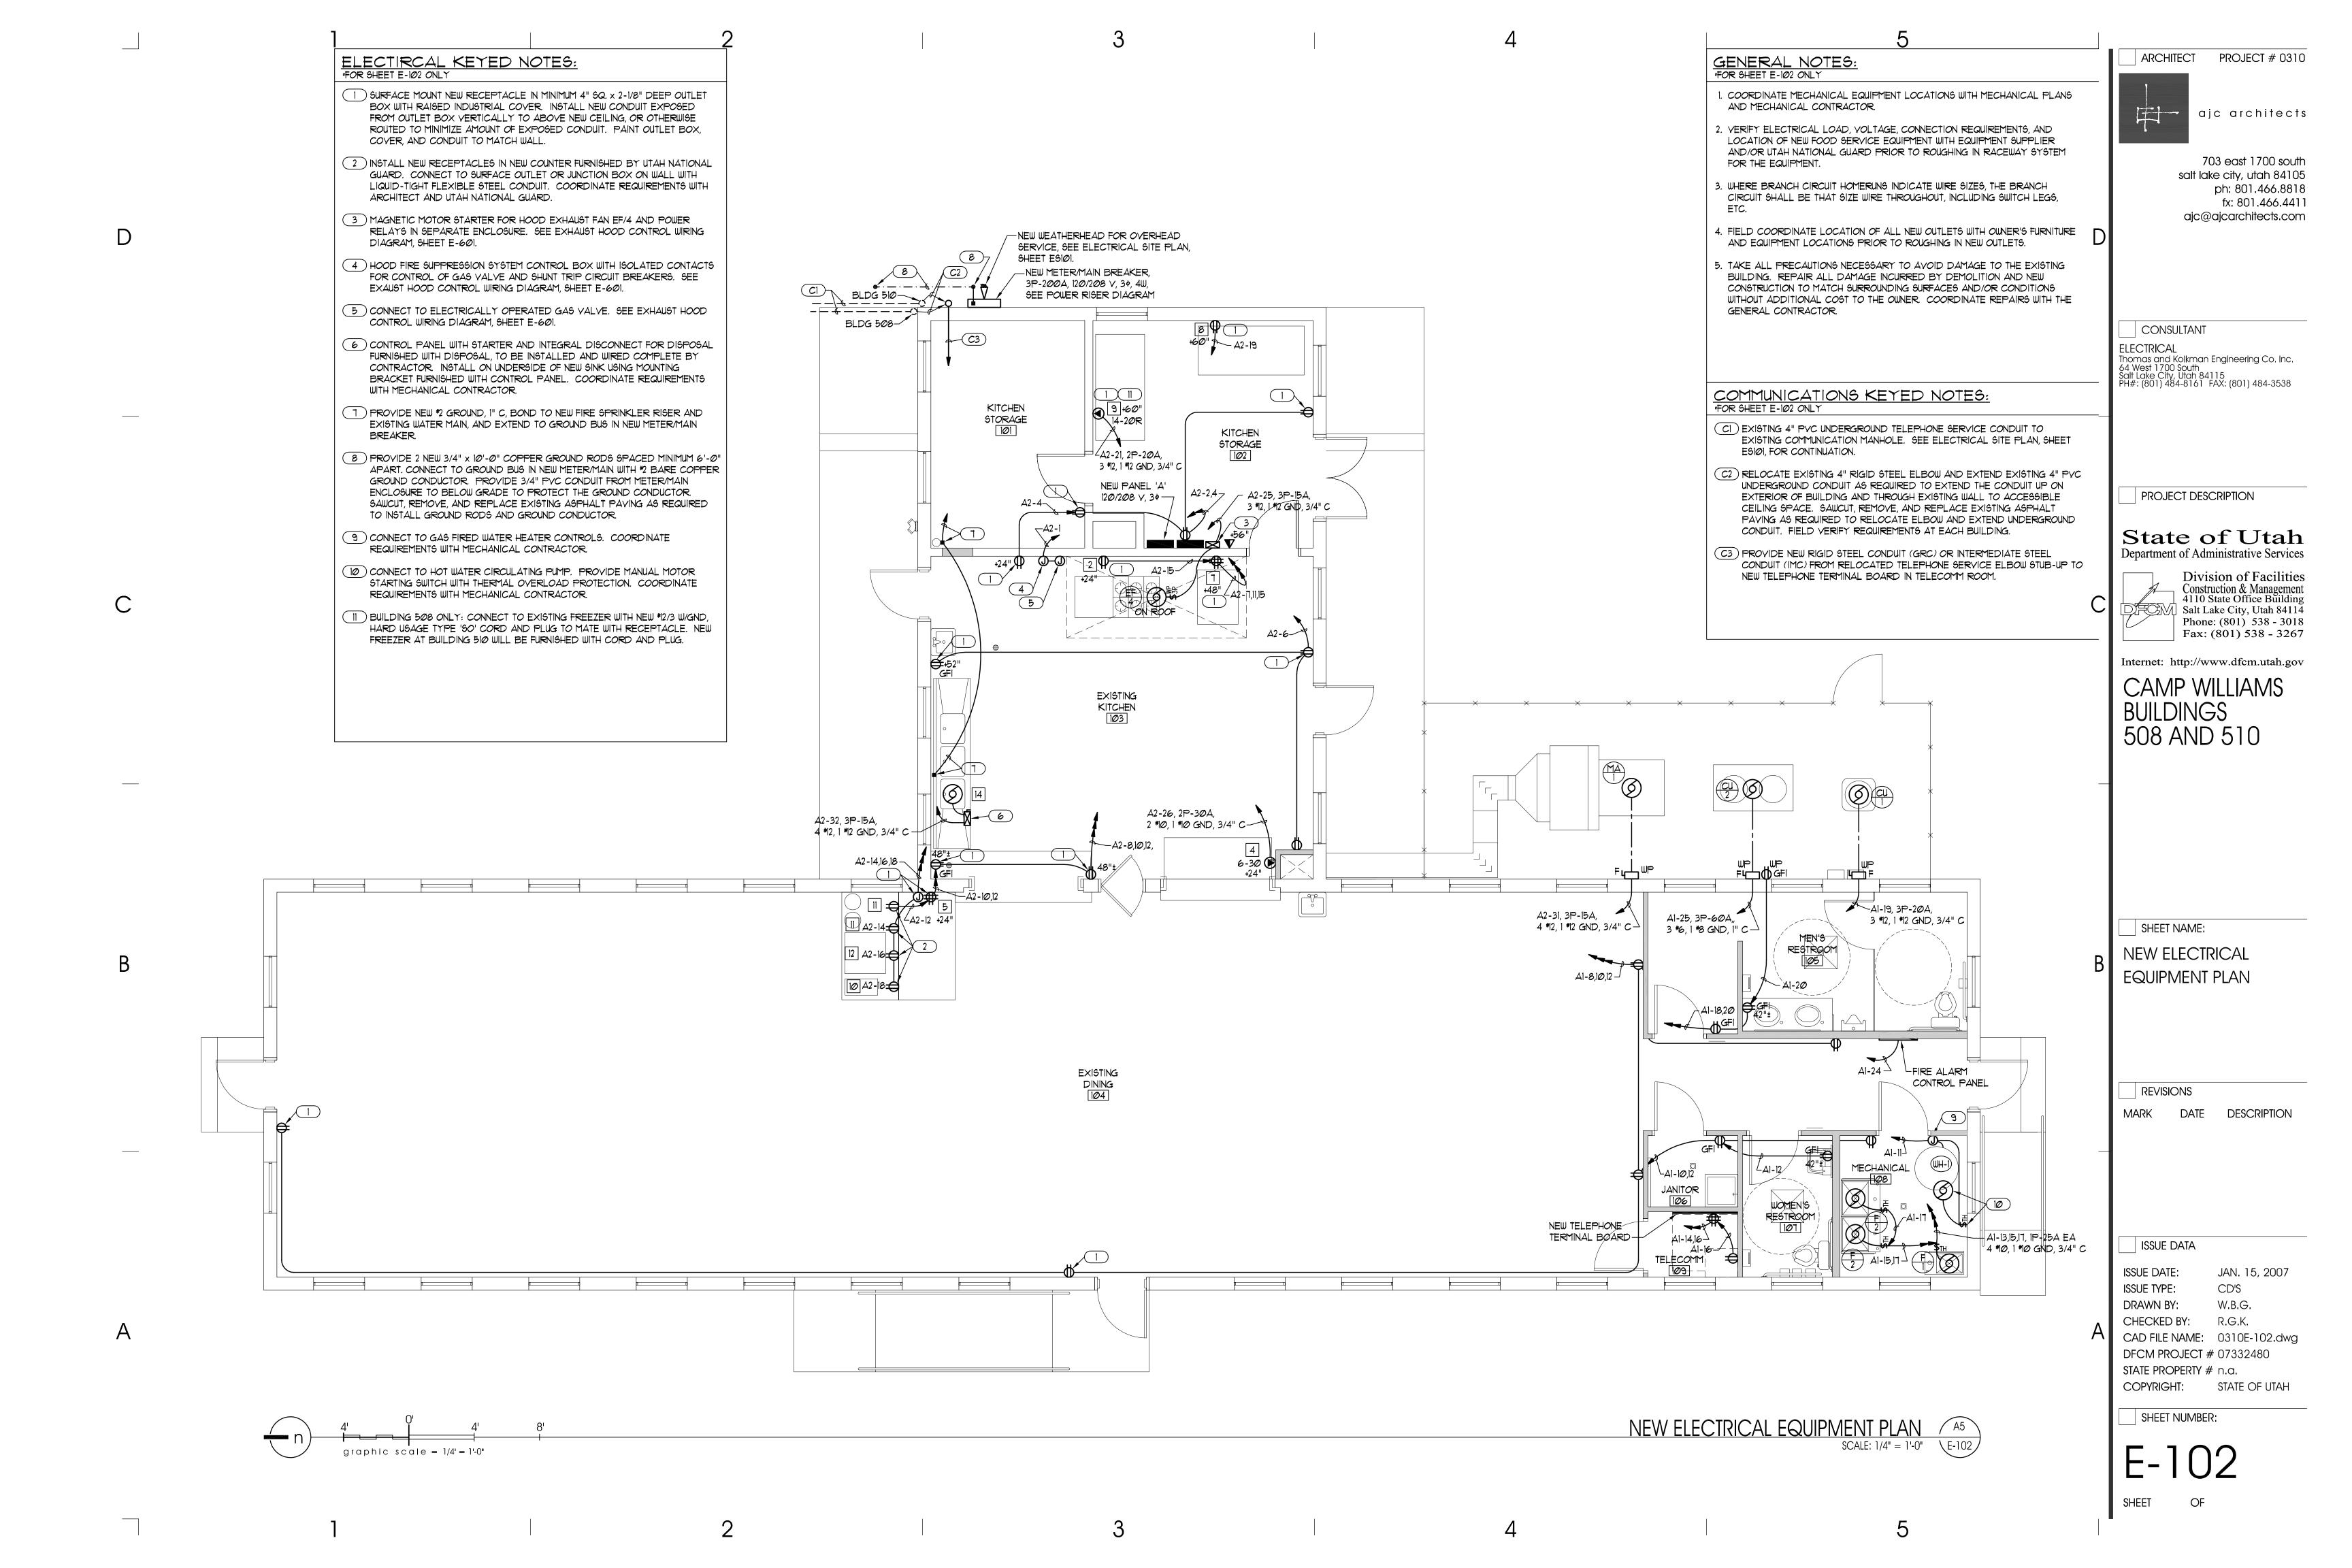

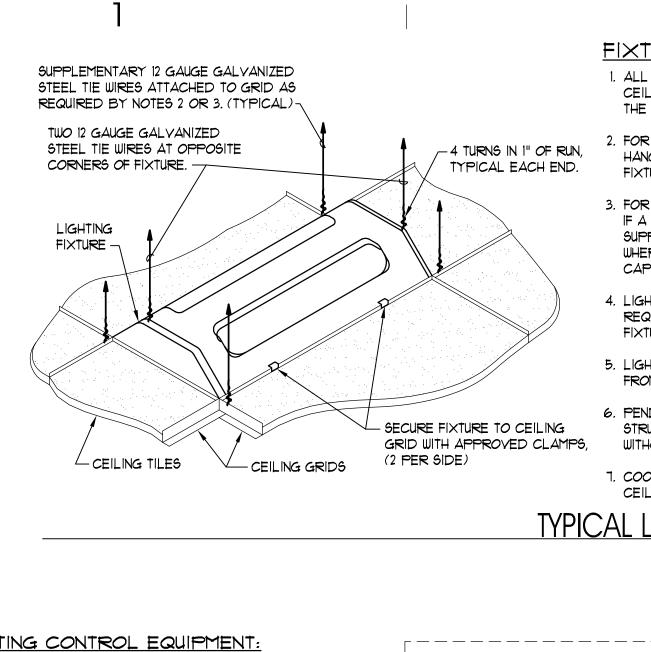

FIXTURE SUPPORT NOTES 1. ALL LIGHTING FIXTURES SHALL BE POSITIVELY ATTACHED TO THE SUSPENDED CEILING SYSTEM. THE ATTACHMENT DEVICE SHALL HAVE A CAPACITY OF 100% OF THE LIGHTING FIXTURE WEIGHT ACTING ANY DIRECTION.

2. FOR INTERMEDIATE DUTY CEILING SYSTEM, PROVIDE A SUPPLEMENTARY 12 GAUGE HANGER ATTACHED TO THE GRID MEMBERS WITHIN 3" OF EACH CORNER OF EACH FIXTURE AS SHOWN ON DETAIL. TANDEM FIXTURES MAY UTILIZE COMMON WIRES.

3. FOR HEAVY DUTY CEILING SYSTEM, SUPPLEMENTARY HANGERS ARE NOT REQUIRED IF A 48" MODULAR HANGER WIRE PATTERN IS USED AND THE LIGHTING FIXTURE IS SUPPORTED FROM MAIN TEES. SUPPLEMENTARY 12 GAUGE HANGERS ARE REQUIRED WHERE THE FIXTURE IS SUPPORTED FROM CROSS TEES WITH LESS CARRYING CAPACITY THAN THE MAIN TEES.

4. LIGHTING FIXTURES WEIGHING LESS THAN 56 LBS. SHALL HAVE, IN ADDITION TO THE REQUIREMENTS OUTLINED ABOVE, TWO 12 GAUGE HANGERS CONNECTED FROM THE FIXTURE HOUSING TO THE STRUCTURE ABOVE. THESE WIRES MAY BE SLACK.

5. LIGHTING FIXTURES WEIGHING 56 LBS. OR MORE SHALL BE SUPPORTED DIRECTLY FROM THE STRUCTURE ABOVE BY APPROVED HANGERS.

6. PENDANT HUNG LIGHTING FIXTURES SHALL BE SUPPORTED DIRECTLY FROM THE STRUCTURE ABOVE USING 9 GAUGE WIRES OR APPROVED ALTERNATE SUPPORT WITHOUT USING CEILING SUSPENSION SYSTEM FOR DIRECT SUPPORT.

 COORDINATE SUPPORT REQUIREMENTS AND HANGER WIRE INSTALLATION WITH CEILING CONTRACTOR.

TYPICAL LIGHTING FIXTURE SUPPORT DETAIL

NOT TO SCALE

EXTERIOR LIGHTING CONTROL EQUIPMENT

- CBI CONTROL CIRCUIT BREAKER, 120 VOLT, 5 AMP THERMAL MAGNETIC TRIP, RAIL MOUNTED: SQUARE D CLASS 9080, TYPE GCB50. INSTALL IN CABINET.
- PCI PHOTOCELL, 2000 WATT, 120 VOLT, WITH SPST CONTACTS: TORK *2101 OR EQUAL. INSTALL OUTSIDE FACING NORTH AND AWAY FROM LIGHT SOURCES.
- CRI INDUSTRIAL CONTROL RELAY WITH 2 N.O. CONTACTS AND 120 YAC COIL: SQUARE D CLASS 8501, TYPE X020V02 OR EQUAL. INSTALL IN CABINET.
- SSI SELECTOR SWITCH, 3 POSITION, MAINTAINED CONTACT, 2 N.Ø. & 2 N.C. CONTACTS: SQUARE D CLASS 9001, TYPE KS43BH3 WITH 9001-KN360 "HAND-OFF-AUTO" ALUMINUM LEGEND PLATE. INSTALL IN COVER OF CABINET.
- LCI LIGHTING CONTACTOR, ELECTRICALLY HELD, 2 POLE, 20 AMP, 120 YAC COIL: SQUARE D CLASS 8903, TYPE L020-Y02 OR EQUAL. INSTALL IN CABINET.

LIGHTING CONTROL CABINET, 12" W x 16" H x 6" D, NEMA 1 ENCLOSURE WITH HINGED FRONT COVER, FLUSH LATCH AND EQUIPMENT MOUNTING PANEL: WIEGMAN *NIC-12166 OR EQUAL.

TERMINAL BLOCKS: 600 VOLT, FOR #22-#8 CONDUCTORS, PROVIDE WITH MOUNTING RAIL, END BARRIERS, ETC., AS REQUIRED: SQUARE D CLASS 9080. TYPE GR6 OR EQUAL. INSTALL IN CABINET AS REQUIRED FOR TERMINATION OF ALL CONDUCTORS TO OUTSIDE OF CABINET.

<u>CONTROL NOTES:</u>

USE MINIMUM #14 STRANDED WIRE FOR ALL CONTROL CONDUCTORS. LABEL WIRE ACCORDING TO NUMBER ON CONTROL DIAGRAM. SEE SPECIFICATION **SECTION 16195.**

. REFER TO ELECTRICAL PLANS FOR POWER WIRE SIZES

- 3. PROVIDE ENGRAVED NAMEPLATE FOR "EXTERIOR LIGHTING CONTROL CABINET" IN ACCORDANCE WITH SPECIFICATION SECTION 16195. PROVIDE SELF-ADHESIVE LABEL TO INCLUDE CIRCUIT NUMBERS OF ALL CONTROL AND POWER CIRCUITS.
- 4. PROVIDE SELF-ADHESIVE LABELS TO IDENTIFY ALL CONTROL DEVICES ACCORDING TO WIRING DIAGRAM.
- 5. PROVIDE DEVICES AS SPECIFIED OR EQUAL OF ACCEPTABLE MANUFACTURERS LISTED IN SPECIFICATION SECTION 16480.

/ IP-20A -12Ø VAC-CONTROL POWER BREAKER / IP-5A PHOTOCELL POWER HAND AUTO PHOTOCELL INTERLOCK PHOTOCELL ON, PHOTOCELL OFF LIGHTING CONTACTOR - EXTERIOR BUILDING LIGHTS LC1-2 - EXTERIOR EMERGENCY LIGHTS - PROVIDE 'AS-BUILT' COPY OF WIRING DIAGRAM ON INSIDE FRONT COVER OF LIGHTING CONTROL CABINET.

EXTERIOR LIGHTING CONTROL WIRING DIAGRAN SCHEMATIC

4" GRC OR IMC TELEPHONE - MINIMUM 3/4" EMT CONDUIT FROM SERVICE CONDUIT THRU BUILDING EACH TELE/DATA OUTLET TO TERMINAL BOARD. (TYPICAL) 1 *6 INSULATED GROUND, 3/4" C TO GROUND BUS IN SERVICE DISCONNECT. -UNISTRUT PIØØO, OR EQUAL, 1 *6 INSULATED GROUND, BOND SUPPORT CHANNEL WITH CLAMPS TO MOUNTING CHANNEL. — TO SUPPORT ALL CONDUITS. TERMINATE SERVICE CONDUIT WITH TERMINATE STATION CONDUITS AT RIGHT GROUNDING BUSHING 12"± ABOVE TERMINAL BOARD AND BOND TO GROUND CONDUCTOR -END OF TERMINAL BOARD WITH INSULATED BUSHING 12"± ABOVE TERMINAL BOARD. PROVIDE 4-11/16" SQ. x 2-1/8" DEEP OUTLET TELEPHONE TERMINAL BOARD, 4'-0" H x BOX WITH SINGLE GANG PLASTER RING AT 4'-0" W x 3/4" PLYWOOD. MOUNT 6'-0" EACH TELEPHONE/DATA OUTLET. SEE NEW ABOVE FLOOR TO TOP. FINISH WITH 2 ELECTRICAL EQUIPMENT PLAN, SHEET COATS OF WHITE FIRE-RETARDANT PAINT. -E-102, FOR QUANTITY AND LOCATION OF LEAVE 6 FT OF *6 CONDUCTOR TELEPHONE/DATA OUTLETS. -DOUBLE DUPLEX RECEPTACLES, SEE COILED AT TERMINAL BOARD. NEW ELECTRICAL EQUIPMENT PLAN, PROVIDE GROUND BUS SUITABLE FOR SHEET E-102, FOR CIRCUITING. EXISTING 4" PYC UNDERGROUND CONNECTION (4) *6 GROUND CONDUCTORS.— TELEPHONE SERVICE CONDUIT TO TELE/DATA RISER NOTES: EXISTING COMMUNICATIONS MANHOLE TO REMAIN. — 1. PROVIDE 200 LB NYLON PULL STRING IN NEW TELE/DATA CONDUITS. - RELOCATE EXISTING 4" GRC ELBOW AND EXTEND EXISTING 2. COORDINATE INSTALLATION OF NEW 4" PYC UNDERGROUND CONDUIT AS REQUIRED TO EXTEND TELE/DATA SERVICE AND SYSTEM WITH UTAH CONDUIT UP ON EXTERIOR OF BUILDING AND THROUGH

REPLACE EXISTING ASPHALT PAYING AS REQUIRED. FIELD

VERIFY REQUIREMENTS AT EACH BUILDING.

NATIONAL GUARD PRIOR TO BEGINNING WORK EXISITING WALL INTO CEILING SPACE. SAWCUT, REMOVE, AND TELEPHONE/DATA RISER DIAGRAM SCHEMATIC \ E-601

HOOD FIRE SUPPRESSION SYSTEM CONTROL PANEL, PROVIDED WITH EXHAUST HOOD.— A2-18 HOOD FIRE SUPPRESSION SYSTEM INTERLOCK RELAY 1P-15A 5, <u>6</u>, 26 GAS VALVE SOLENOID UPPER CONVECTION OVEN LOWER CONVECTION OVEN GAS RANGE CONTROLS EXHAUST HOOD SWITCH HEAT SENSOR RELAY 11 EXHAUST HOOD SWITCH INTERLOCK RELAY 19, 26 EXAHAUST FAN 'ON' 3P-7A MCP 3P-15A OL'S HOOD EXHAUST FAN 1 HP, 208 V, 3¢ CONTROL POWER HOOD EXHAUST FAN CONTROLS JUMPER 3P-15A MAKE-UP AIR UNIT FAN MAKE-UP AIR UNIT CONTROLS - 11, 15, 22

EXHAUST HOOD CONTROL EQUIPMENT

MS-1 NORMALLY CLOSED DRY CONTACT IN HOOD FIRE SUPPRESSION SYSTEM CONTROL PANEL FURNISHED WITH EXHAUST HOOD, TO BE WIRED COMPLETE BY ELECTRICAL CONTRACTOR.

RI POWER RELAY, ELECTRICALLY HELD WITH DPDT, 30 AMP, 300 VOLT CONTACTS AND 120 VAC R2 COIL: SQUARE D CLASS 8501, TYPE CO16 V20 OR EQUAL. INSTALL IN 12" W x 12" H x 6" D, NEMA 1 ENCLOSURE WITH HINGED FRONT COVER, FLUSH LATCH AND EQUIPMENT MOUNTING PANEL: WIEGMAN *NIC-121206 OR EQUAL

GVI ELECTRICALLY OPERATED GAS SOLENOID VALVE, FURNISHED BY PLUMBING CONTRACTOR, TO BE WIRED COMPLETE BY ELECTRICAL CONTRACTOR.

STX SHUNT TRIP CIRCUIT BREAKER COIL FOR ELECTRICALLY OPERATED EQUIPMENT UNDER EXHAUST HOOD. SEE PANEL SCHEDULES.

5W-1 MANUAL SWITCH FURNISHED WITH EXHAUST HOOD, TO BE WIRED COMPLETE BY CONTRACTOR.

HS AUTOMATIC HEAT SENSOR FURNISHED WITH EXHAUST HOOD, TO BE WIRED COMPLETE BY CONTRACTOR HEAT SENSOR TO BE ACTIVATED BY HEAT FROM COOKING APPLIANCES FOR AUTOMATIC OPERATION OF THE HOOD EXHAUST FAN.

SW-PL PILOT LIGHT FURNISHED WITH EXHAUST HOOD, TO BE WIRED COMPLETE BY CONTRACTOR.

MI COMBINATION MAGNETIC MOTOR STARTER, NEMA SIZE Ø FVNR, WITH MCP DISCONNECT IN NEMA I CPT ENCLOGURE: SEE SPECIFICATION SECTION 16480. FURNISH COMPLETE WITH CONTROL 661 TRANSFORMER 'CPT', HAND-OFF-AUTO SELECTOR SWITCH '561', RED 'RUN' PILOT LIGHT 'PLI', 2 N.O. & PLI 2 N.C. AUXILIARY CONTACTS, AND THERMAL OVERLOAD RELAY.

DSI FUSED SAFETY SWITCH, 3 POLE, 30 AMPERE, NEMA 3R ENSLOSURE, IN ACCORDANCE WITH SPECIFICATION SECTION 16440.

M2 MAKE-UP AIR UNIT STARTER FURNISHED WITH MAKE-UP AIR UNIT. SEE MECHANICAL PLANS AND SPECIFICATIONS.

FA-X FIRE ALARM SYSTEM FIRE SAFETY FUNCTION CONTROL RELAY FOR MAKE-UP AIR UNIT FAN SHUT DOWN. SEE FIRE ALARM PLAN, SHEET FAIØI.

KEYED NOTES:

 $(\ \)$) MAKE-UP AIR UNIT WILL BE FURNISHED WITH FACTORY WIRED STARTER AND CONTROLS, SEE MECHANICAL PLANS AND SPECIFICATIONS. BASIC CONTROL (DASHED LINES) IS SHOWN FOR REFERENCE ONLY. SUBMIT COPY OF MAKE-UP AIR UNIT INSTALLATION WIRING DIAGRAM TO ENGINEER FOR RECOMMENDED MODIFICATIONS TO WIRING DIAGRAM IF NECESSARY.

GENERAL CONTROL NOTES:

1. USE MINIMUM #14 STRANDED WIRE FOR ALL CONTROL CONDUCTORS. LABEL WIRE ACCORDING TO NUMBER ON CONTROL DIAGRAM. SEE SPEC. SECTION 16195.

2. REFER TO ELECTRICAL PLANS FOR POWER WIRE SIZES.

3. PROVIDE ENGRAVED NAMEPLATE FOR STARTER ENCLOSURES, "EXHAUST HOOD CONTROL CABINET", ETC., IN ACCORDANCE WITH SPECIFICATION SECTION 16195. PROVIDE SELF-ADHESIVE LABEL TO INCLUDE CIRCUIT NUMBERS OF ALL CONTROL AND POWER CIRCUITS.

4. PROVIDE SELF-ADHESIVE LABELS TO IDENTIFY ALL CONTROL DEVICES ACCORDING TO WIRING

5. PROVIDE DEVICES AS SPECIFIED OR EQUAL OF ACCEPTABLE MANUFACTURERS LISTED IN SPECIFICATION SECTION 16480.

6. PROVIDE "AS-BUILT" COPY OF WIRING DIAGRAM IN THE ENCLOSURE OF EACH APPROPRIATE STARTER AND/OR CONTROL CABINET.

EXHAUST HOOD CONTROL WIRING DIAGRAM

SHEET NAME:

ARCHITECT

CONSULTANT

Thomas and Kolkman Engineering Co. Inc.

64 West 1700 South Salt Lake City, Utah 84115 PH#: (801) 484-8161 FAX: (801) 484-3538

PROJECT DESCRIPTION

State of Utah

Department of Administrative Services

Internet: http://www.dfcm.utah.gov

CAMP WILLIAMS

BUILDINGS

508 AND 510

Division of Facilities

Construction & Management

4110 State Office Building

Salt Lake City, Utah 84114

Phone: (801) 538 - 3018

Fax: (801) 538 - 3267

PROJECT # 0310

ajc architects

703 east 1700 south

ph: 801.466.8818

fx: 801.466.4411

salt lake city, utah 84105

ajc@ajcarchitects.com

LECTRICAL RISERS AND WIRING DIAGRAMS

REVISIONS

MARK DATE DESCRIPTION

ISSUE DATA

ISSUE DATE: JAN. 15, 2007 ISSUE TYPE: CD'S DRAWN BY: W.B.G.

CHECKED BY: R.G.K. CAD FILE NAME: 0310E-601.dwg DFCM PROJECT # 07332480

STATE PROPERTY # n.a. COPYRIGHT: STATE OF UTAH

SHEET NUMBER:

EXISTING 12,470/7,200 VOLT, 3 PHASE, 4 WIRE OVERHEAD PRIMARY DISTRIBUTION LINE TO REMAIN. --NEW STIRRUP WITH HOT LINE CLAMP (TYP) NEW 10.0 KY SURGE ARRESTOR ■ NEW FUSED CUTOUT WITH 5 E STANDARD (TYPICAL OF 3) -SPEED FUSE (TYPICAL OF 3) NEW (3) 25 KVA SINGLE PHASE POLE MOUNTED PROVIDE NEW CROSSARM AND TRANSFORMERS, 7,200 VOLT TO 120 V, 14, SUITABLE MOUNTING BRACKETS ON CONNECTED FOR 120/208 V, 34, 4W, SERVICE. EXISTING POLE TO SUPPORT FUSED INSTALL ON EXISTING POLE. SEE ELECTRICAL CUTOUTS AND SURGE ARRESTORS. -SITE PLAN, SHEET ESIØI, FOR LOCATION. SHORT CIRCUIT AMPERE (SCA) BASED ON PROVIDE TRANSFORMER TAP EQUAL TO BURNDY TYPE (3) 25 KVA TRANSFORMERS, INFINITE PRIMARY 'FCP' AND SUITABLE LUGS FOR MULTIPLE CONDUCTOR BUS AND ESTIMATED 1.25% Z, FOR 16,654 CONNECTIONS TO SECONDARY TERMINALS. (TYPICAL) SCA AT TRANSFORMER SECONDARY TERMINALS. NEW WEATHERHEAD, NEW *3/Ø AL, QUADRUPLEX -NEW *3/Ø AL, QUADRUPLEX 20 FT± ABOVE GRADE--NEW WEATHERHEAD, CABLE OVERHEAD -CABLE OVERHEAD 20 FT± ABOVE GRADE CONNECT ALUMINUM CONDUCTORS TO COPPER CONDUCTORS USING BLACKBURN NEW *2 B.C. TO - CONNECT ALUMINUM CONDUCTORS TO TYPE 'WR', OR EQUAL, COMPRESSION H-TAP GROUND ROD-COPPER CONDUCTORS USING BLACKBURN -18'-0" MINIMUM 18'-0" MINIMUM CONNECTORS WITH BLACKBURN TYPE 'C', TYPE 'WR', OR EQUAL, COMPRESSION H-TAP ABOVE GRADE ABOVE GRADE OR EQUAL, INSULATING COVERS. CONNECTORS WITH BLACKBURN TYPE 'C', OR EQUAL, INSULATING COVERS. NEW 4 *3/0 CU NEW 4 *3/0 CU, 2" GRC ---2" GRC ---1 *4 GND, 2" C 1 *4 GND, 2" C 4,847 SCA-4,367 SCA-4,746 SCA-5,319 SCA-\ NEW KWH DEMAND METER BY NEW KWH DEMAND METER BY CONTRACTOR, SEE SPECIFICATION CONTRACTOR, SEE SPECIFICATION SECTION 16400. (TYPICAL) -BLDG 508 SECTION 16400. (TYPICAL) -<u>BLDG 510</u> NEW METER/MAIN COMBINATION, 120/208 V, 34, NEW METER/MAIN COMBINATION, 120/208 V, 34, 4W, NEMA 3R ENCLOSURE, 200 AMP 4W, NEMA 3R ENCLOSURE, 200 AMP TWO SECTIONS TWO SECTIONS BREAKER, 10,000 A.I.C. MIMIMUM, SUITABLE BREAKER, 10,000 A.I.C. MIMIMUM, SUITABLE OF THE SAME OF THE SAME FOR OVERHEAD OR UNDERGROUND SERVICE. L FOR OVERHEAD OR UNDERGROUND SERVICE. PHYSICAL SIZE PHYSICAL SIZE SEE SPEC. SECTION 16400. (TYPICAL) SEE SPEC. SECTION 16400. (TYPICAL) ----NEW PANEL 'A' NEW PANEL 'A' NEW *2 GND, 3/4" PVC-NEW #2 GND, 3/4" PVC -FUTURE UNDERGROUND 12*0*/2*0*8 V, 3¢ FUTURE UNDERGROUND 12*0*/2*0*8 V, 3¢ NEW #2 BC, ELECTRICAL SERVICE -ELECTRICAL SERVICE — — NEW 1 *2 GND, 1" C, BOND NEW *2 BC, 24" BELOW GRADE-24" BELOW GRADE-TO BLDG WATER AND TO BLDG WATER AND EXOTHERMIC WELD EXOTHERMIC WELD FIRE SPRINKLER MAINS, FIRE SPRINKLER MAINS, EXOTHERMIC WELD (TYPICAL)---(TYPICAL)— SEE SHEET E-102. SEE SHEET E-102. NEW 3/4" x 10'-0" NEW 3/4" x 10'-0" COPPER NEW 3/4" x 10'-0" COPPER COPPER GROUND ROD-GROUND RODS SPACED GROUND RODS SPACED MINIMUM 6'-0" APART. MINIMUM 6'-0" APART. -**POWER RISER DIAGRAM** SCHEMATIC

\ E-601

SHEET

4PS24-332G-FSA12. 125-EB8LH-120

50G-S24-332-SA12125-EBLH2/1-120

2SPG332-FSACT. 140-120-1/21-EB10

50GS24-332-SAT140INV-EBLH2/1-120

4PS24-232G-FSA12. 125-EB8LH-120

4PS24-332G-FSDR12-EB8LH-120

2GC332-ACT. 140INV-120TEB82

2SPG232-FS21-120-1/2-EB10

2SP8G232-A12125-120GEB10

WAL4-1U1D32-EB8LH-120-LUB

CAW332-120-1/3-EB10/CR-2W

WB340-120-0310%THD-DSM

300-D-W-L-70MH-120-BRP

LE-S-W-1-G-120/277-ELN

LE-S-W-2-G-120/277-ELN

SR40919-37-43/70MH-89-WB/3"

50G-S24-232-SA12125-EBLH2-120

2SPG332-FS21-120-1/21-EB10

2SP8G332-A12125-120GEB10

SPS2GFSVI332-120-HI

2GC332-A125-120TEB82

SPS2GFSVK332-120-HI

| SPS2GFSVI232-120-HI

2GC232-A125-120TEB81

CB232-120-1/2-EB10

WP-232-120-GEB10

BIU-232-120-TEB81

WB-232-SSD-10%-120

WCW4-332-3EB8LH-120

LB332-1/3-120GEB10

PR-332-SSD-10%-120

WS332A-120-TEB81

CX-L-N-1-G-W

DX-L-N-1-G-W

ER30VL-1-W-G

CAX-717000-G-W

CX-L-N-2-G-W

DX-L-N-2-G-W

ER30VL-2-W-G

CAX-727000-G-W

V12-100-W-0TTD

XD2GEN-WH

U-H1212-G

1 | 1 | 15 | HOOD SUPPRESSION SYSTEM | 500 | 1,040

XD1GEN-WH

LWBX232-120-S010%THD

2SP8G332-AR12-120GEB10

SYMBOL MANUFACTURER | CATALOG NUMBER

| F-1 | COLUMBIA

DAY-BRITE

LIGHTOLIER

LITHONIA

METALUX

WILLIAMS

COLUMBIA

DAY-BRITE

LITHONIA

METALUX

WILLIAMS

DAY-BRITE

LIGHTOLIER

LITHONIA

METALUX

WILLIAMS

COLUMBIA

DAY-BRITE

LITHONIA

METALUX

MIDWEST

DAY-BRITE

LITHONIA

METALUX

MIDWEST

GARDCO

KIRLIN

LIGHTGUARD

LITHONIA

MCPHILBEN

PRESCOLITE

SURE-LITES

LIGHTGUARD

LITHONIA

MCPHILBEN

PRESCOLITE

SURE-LITES

F-7 | CHLORIDE

| F-7A | CHLORIDE

F-8 LIGHTGUARD

F-9 LIGHTGUARD

PANEL 'A2'

3 | 1 | 20 | SPARE

5 | 1 | 20 | SPARE

NO. P AMPS DESCRIPTION

TYPE 'NQOD', BOLT-ON

3 POLE 225 AMP MAIN LUGS

7 | 1 | 20* | UPPER CONVECTION OVEN

11 | 1 | 20* | LOWER CONVECTION OVEN

17 - - (SHUNT TRIP MODULE)

21 2 20 REC, FREEZER, STORAGE

25 3 15 HOOD EXHAUST FAN EF/4

19 1 20 REC, REFRIG., STOR.

15 1 20* RANGE CONTROLS

9 - - (SHUNT TRIP MODULE)

LIGHTOLIER

F-5 | COLUMBIA

LIGHTOLIER

| F-3 | COLUMBIA

LIGHTOLIER

SAME AS F-1 EXCEPT WITH KSH 'ACRI-TUF', DR EQUAL, 0.140" | 3F32T8/TL835

2' x 4', 3 LAMP, LAY-IN FLUORESCENT FIXTURE WITH FLAT

1 LAMP AND ONE 2 LAMP, 120 VOLT, <10% THD ELECTRONIC

| BALLASTS WIRED FOR INBOARD/OUTBOARD LAMP OPERATION.

INVERTED TO INSIDE OF FIXTURE.

ELECTRONIC BALLAST.

| VOLT, <10% THD ELECTRONIC BALLAST

STEEL DOOR, 0.125" THICK ACRYLIC PRISMATIC LENS AND ONE

THICK, PATTERN 12, HIGH IMPACT ACRYLIC LENS WITH PRISMS

 $|2' \times 4'$, 2 LAMP, LAY-IN FLUORESCENT FIXTURE WITH FLAT

2 LAMP, 120 VOLT, <10% THD ELECTRONIC BALLAST.

4 FT, 2 LAMP WALL MOUNTED FLUORESCENT FIXTURE WITH

WHITE FINISH AND DNE 2 LAMP, 120 VOLT, <10% THD

INJECTION MOLDED ACRYLIC PRISMATIC LENS, UP & DOWNLIGHT,

4 FT, 3 LAMP SURFACE MOUNTED 'WRAPAROUND' FLUORESCENT

WALL MOUNTED METAL HALIDE DOWNLIGHT WITH ALUMINUM

HOUSING, TEMPERED PRISMATIC GLASS LENS, DARK BRONZE FINISH, AND 120 VOLT HIGH POWER FACTOR BALLAST. MAXIMUM

9" DIAMETER × 14" HIGH CYLINDER, AND MAXIMUM 13" OVERALL

EXTENSION FROM WALL. UL LISTED FOR DUTDOOR WET LOCATION.

UNIVERSAL MOUNTED, SINGLE FACE, LIGHT EMITTING DIODE

FINISH, GREEN LETTERS ON STENCIL FACE, NICKEL CADMIUM

UNIVERSAL MOUNTED, DOUBLE FACE, LIGHT EMITTING DIODE

FINISH, GREEN LETTERS ON STENCIL FACE, NICKEL CADMIUM

FOR REMOTE FEED, STEEL HOUSING, MINIMUM 75 WATT 12 VOLT

LEAD CALCIUM BATTERY, CHARGER, 120/277 VOLT INPUT, SELF-DIAGNOSTIC CIRCUITRY WITH INDICATORS AND TEST SWITCH,

12 VOLT HALOGEN LAMP, GASKETED POLYCARBONATE DIFFUSER,

AND WHITE FINISH. UL LISTED DUTDOOR WET LOCATION.

| WALL MOUNTED EMERGENCY LIGHTING UNIT WITHOUT LAMP HEADS | NOT REQ'D

| WALL MOUNTED REMOTE EMERGENCY LIGHT FIXTURE WITH 12 WATT | FURNISHED W/

(LED) EXIT LIGHT WITH CAST ALUMINUM HOUSING, WHITE

(LED) EXIT LIGHT WITH CAST ALUMINUM HOUSING, WHITE

BATTERY PACK WITH CHARGER & TEST SWITCH.

BATTERY PACK WITH CHARGER & TEST SWITCH.

AND 15 MINUTE HID TIME DELAY.

DOUBLE PANEL - SECTION II

NO. NO. CIRCUIT PHASE LOAD - VA CIRCUIT NO. NO. DESCRIPTION

FIXTURE WITH ACRYLIC PRISMATIC LENS AND DNE 3 LAMP, 120

STEEL DOOR, 0.125" THICK ACRYLIC PRISMATIC LENS AND ONE

FIXTURE SCHEDULE

LAMP

3F32T8/TL835

2F32T8/TL835

2F32T8/TL835

3F32T8/TL835

FURNISHED W/

FURNISHED W/

FIXTURE

FIXTURE

10,000 A. I. C. FULLY RATED

SURFACE MOUNTED

BRKR CIE

P AMPS NO.

120/208 VOLT, 3 PHASE, 4 WIRE

540 3 REC, STORAGE ROOMS

1,500 1 REC, DINING COUNTER

1,500 1,500 1 REC, DINING COUNTER

180 1

540 3

1,500 2

1,500 1

2,500 1

2,580 1,500 1

1, 405

REC, KITCHEN, EAST WALL

REC, KITCHEN, NO. & SO.

REC, COLD FOOD TABLE

REC, DINING COUNTER

REC, DINING COUNTER

HOT FOOD WELL

DISPOSAL

SPACE

SPACE


FEEDER: 4 #3/0, 1 #4 GND, 2" C

REC, KITCHEN, WEST CNTR

FIXTURE

PROJECT # 0310

ARCHITECT

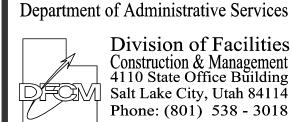

Phone: (801) 538 - 3018 Fax: (801) 538 - 3267

Internet: http://www.dfcm.utah.gov CAMP WILLIAMS

SHEET NAME: **ELECTRICAL SCHEDULES**

AND SYMBOL LIST

REVISIONS MARK DATE DESCRIPTION

ISSUE DATA ISSUE DATE: JAN. 15, 2007 ISSUE TYPE: CD'S DRAWN BY: W.B.G.

CHECKED BY: R.G.K. CAD FILE NAME: 0310E-602.dwg DFCM PROJECT # 07332480 STATE PROPERTY # n.a. COPYRIGHT: STATE OF UTAH

SHEET NUMBER:

MECHANICAL EQUIPMENT SCHEDULE														
EQUIP. NO.	DESCRIPTION	CIRCUIT NUMBER	VOLTS	PHASE	WATTS H.P.	BREAKER		STARTERS FURNISH INSTALL		AUX. CONT.	LOCATION			
EF 1	CEILING EXHAUST FAN	A1-5	120	1	35 WATTS	IP-20A	E	E	\$ _{TH}	-	JANITOR 106			
EF 2	CEILING EXHAUST FAN	A1-5	120	1	9Ø WATTS	IP-20A	E	E	\$ _{TH}	-	WOMEN'S RESTROOM 101			
EF 3	CEILING EXHAUST FAN	A1-5	120	1	184 WATTS	IP-20A	E	Ħ	\$ _{TH}	-	MEN'S RESTROOM 105			
EF 4	GREASE HOOD EXHAUST FAN	A2-25	208	3	1 HP	3P-15A	E	Ш	0	2 N.O. 2 N.C.	ON ROOF KITCHEN 1003			
F 1	FURNACE	A1-13	120	1	1/2 HP	IP-20A	E	E	\$ _{TH}	-	MECHANICAL 108			
F 2	FURNACE	A1-15	120	1	1 HP	IP-30A	E	E	\$ _{TH}	-	MECHANICAL 108			
F 3	FURNACE	A1-17	120	1	1 HP	IP-30A	E	E	\$ _{TH}	-	MECHANICAL 108			
CU 1	AIR COOLED CONDENSING UNIT	A1-19	208	3	11.4 F.L.A.	3P-2ØA	M	М	М	-	OUTSIDE			
CU 2	AIR COOLED CONDENSING UNIT	A1-25	208	3	40.8 AMPS	3P-60A	M	М	М	-	OUTSIDE			
MA 1	MAKE-UP AIR UNIT	A2-31	208	3	1-1/2 HP	3P-15A	M	М	М	-	OUTSIDE			
WH-1	GAS FIRED WATER HEATER (IGNITION CONTROLS)	A1-11	120	1	Ø.7 AMP	IP-20A	М	М	\$	-	MECHANICAL 108			
WH-1)	HOT WATER CIRCULATING PUMP	A1-11	120	1	1/6 HP	IP-20A	E	E	\$ _{TH}	-	MECHANICAL 108			

E - ELECTRICAL CONTRACTOR M - MECHANICAL CONTRACTOR

	FOOD SERVICE EQUIPMENT SCHEDULE														
EQUIP. NO.	DESCRIPTION	CIRCUIT NUMBER	VOLTS	PHASE	LOAD	BREAKER	DEVICE	MNTG HEIGHT	REMARKS	NOTES	ROOM NO.				
1	BOOSTER HEATER - DELETED														
2	RANGE GRILLE	A2-15	120	1	3 AMP	IP-20A	b 5-20R	+24"	FUTURE ELECTRONIC IGNITION	1	1Ø3				
4	HOT FOOD COUNTER	A2-26	208	1	5,000 W	2P-3ØA	● 6-30R	+24"	PROVIDE *8 CORD & PLUG	1, 2	103				
5	COLD FOOD COUNTER	A2-10	120	1	YERIFY	IP-20A	5 -20R	+18"	FURNISHED W/CORD & PLUG	1	104				
7	DOUBLE CONVECTION OVEN	A2-7,11	120	1	9 FLA EA	IP-20A	5 -20R	+48"	FURNISHED W/CORD & PLUG	1	1Ø3				
8	3 DOOR REFRIGERATOR	A2-19	120	1	12 FLA	IP-20A	5 -20R	+60"	FURNISHED W/CORD & PLUG	1	102				
9	3 DOOR FREEZER	A2-21	120/208	1	10.5 FLA	2P-2ØA	(14-2 Ø R	1 60"	FIELD VERIFY CONNECTION	1	1002				
10	BREAD DISPENSER	A2-18	120	1	VERIFY	IP-20A	5 -20R	+18"	FURNISHED W/CORD & PLUG	1	104				
11	COFFEE POT (2)	AS-12,14	120	1	VERIFY	IP-20A	5 -20R	+18"	FURNISHED W/CORD & PLUG	1	104				
12	BEVERAGE DISPENSER	AS-16	120	1	2.5 FLA	IP-20A	5 -20R	+18"	FURNISHED W/CORD & PLUG	1	104				
14	DISPOSAL	A2-32	208	3	2 HP	3P-15A	\square		STARTER FURNISHED W/ EQUIP	1, 3	104				
<u> </u>															

PANE	L 'A1'				DOUBLE	PANEL - SE	CTION I		10,000 A. I.C. FULLY RATED					
TYPE	′NQOD′, BOLT-ON							120/208 VOLT, 3 PHASI	Ξ, 4	WIR	.E			
3 PO	LE 225 AMP MAIN LUGS									SURFACI	E MO	UNTE	.D	
IR BRK	DESCRIPTION	ND.	N□.	CIRCUIT	PH	PHASE LOAD - VA			N□.	N□.	DESCRIPTION		BRKR	CI
NO. P AN	1. P AMPS		REC		PHASE A	PHASE B	PHASE C	LOAD	REC	LTS	DESCRIPTION	Р	AMP	S NO
1 1 2	20 LTS, DINING	24		1,440	1, 940			500			HOOD LIGHTS	1	20	2
3	LTS, DINING	26		860		2,000		1,140		16	LTS, KITCHEN & STORAGE			4
5	LTS, HALL, RESTRMS, .	JAN 11		870			1, 490	620		7	DUTSIDE LIGHTS			6
7	SPARE				900			900	5		REC, DINING AREA			8
9	SPARE					360		360	2		REC, JANITOR & MECH			10
11 1 2	20 WATER HTR & CIRC PUMP)		610			790	180	1		REC, WOMEN'S			12
13 1 2	PO FURNACE F/1, MECH RM			1, 125	1, 485			360	2		REC, TELEPHONE RM			14
15 1 3	BO FURNACE F/2, MECH RM			1,840		2, 020		180	1		REC, TELEPHONE RM			16
17 1 3	BO FURNACE F/3, MECH RM			1,840			2, 200	360	2		REC, MEN'S			18
19 3 2	20 COND. UNIT CU/1, OUT:	SIDE		1,370	1,550			180	1		REC, DUTSIDE AT CU's			20
21 -	- -			1,370		1,370					SPARE			22
23 -	- -			1,370			1,870	500			FIRE ALARM PANEL			24
25 3 6	50 COND. UNIT CU/2, DUTS	SIDE		4, 895	4, 895						SPARE			26
27 -	- -			4, 895		4, 895					SPARE			28
29 -	- -			4, 895			4, 895				SPARE	1	20	
31 1	SPACE				0						SPACE	1		32
33						0						Ш		34
35							0							36
37					0									38
39						0								40
41 1	SPACE						0				SPACE	1		42
					10,770	10, 645	11, 245							
		32,660	VA	91 AMPS		FEE	DER:	DER: 4 #3/0, 1 #4 GND, 2" C						
	CALCULATED FE	37,814 VA 105 AMPS												

PANEL '	Δ1'				DOUBLE	PANEL - SE	CTION I				10,000 A. I.C. FULLY RATED						
	IQOD', BOLT-ON			DEODEL	THINEE OE	JIIIIV I				12	20/208 VOLT, 3 PHASE						
	225 AMP MAIN LUGS											SURFACE	•				
CIR BRKR	DECORAGE	N□.	NΠ.	CIRCUIT	PHA	ASE LOAD -	LOAD - VA CIRCUIT NO.				DECOR		BRKR		CIR		
NO. P AMPS	DESCRIPTION		REC	LOAD	PHASE A	PHASE B	PHASE C			LTS	DEZCK	IPTION	Р	AMPS			
1 1 20	LTS, DINING	24		1,440	1, 940			500			HOOD	LIGHTS	1	20	2		
	LTS, DINING	26		860		2, 000		1, 140		16	LTS,	KITCHEN & STORAGE			4		
5	LTS, HALL, RESTRMS, JAN	11		870			1, 490	620		7		DE LIGHTS			6		
7	SPARE				900			900	5			DINING AREA			8		
9	SPARE					360		360	2			JANITOR & MECH			10		
	WATER HTR & CIRC PUMP			610			790		1			WOMEN'S			12		
	FURNACE F/1, MECH RM			1, 125	1, 485			360	2			TELEPHONE RM			14		
	FURNACE F/2, MECH RM			1,840		2, 020		180	1			TELEPHONE RM			16		
	FURNACE F/3, MECH RM			1,840			2, 200		2		REC,				18		
19 3 20	COND. UNIT CU/1, OUTSIDE			1,370	1,550			180	1			OUTSIDE AT CU's			20		
21	-			1,370		1, 370					SPARE				22		
23	-			1,370			1,870	500				ALARM PANEL			24		
	COND. UNIT CU/2, DUTSIDE			4, 895	4, 895						SPARE				26		
27 – –	-			4, 895		4, 895					SPARE				28		
29 – –	-			4, 895			4, 895				SPARE		1	20	30		
31 1	SPACE				0	_					SPACE		1	<u> </u>	32		
33						0								<u> </u>	34		
35							0						$\perp \mid \perp$	<u> </u>	36		
37					0	_									38		
39						0							1.	<u> </u>	40		
41 1	SPACE					0				SPACE		1		42			
					10, 770	10, 645	11, 245										
	TOTAL	32, 660	VA	91 AMPS		FEEDER: 4 #3/0, 1 #4 GND, 2" C											
	CALCULATED FEEDER	37,814	VA	105 AMPS													

								_				
10	BREAD DISPENSER	A:	2-18	120	1	VERIFY	IP-20A	5-20R	+18"	FURNISHED W/CORD & PLUG	1	1004
11	COFFEE POT (2)	AS	-12,14	120	1	VERIFY	IP-2ØA	b 5-20R	+18"	FURNISHED W/CORD & PLUG	1	104
12	BEVERAGE DISPENSER	A	5-16	120	1	2.5 FLA	IP-2ØA	b 5-20R	+18"	FURNISHED W/CORD & PLUG	1	104
14	DISPOSAL	A	2-32	208	3	2 HP	3P-15A	⊠		STARTER FURNISHED W/ EQUIP	1, 3	104
	FOOD SERY 1. VERIFY ELECTRIC SERVICE EQUIPME IN RACEWAY SYSTEM ATTEMPT OF MATE WITH RECEPTION ARRANGED TO BE ARRANGED TO BE REQUIRE ELECTRIC FOR ADDITIONAL	EAL LOAD ENT WITH TEM FOR ON TO PO PTACLE. ONS TO HA E MINIMUN O SERVICIC POWER	D, YOLTA EQUIPME THE EQU PRTABLE ARD-WIR M 12" ABO CE EQUIP R. GEE A	GE, CO ENT SUIF IIPMEN EQUIF RED EG OVE FL MENT I	ONNEC PPLIEF T. MENT QUPMEI LOOR. NUMBE ECT'S	TION REQUIR RAND/OR UT WITH HARD L NT WITH LIQU RS NOT INCL FOOD SERV	REMENTS AI TAH NATION ISAGE TYP ID-TIGHT F LUDED IN A ICE PLAN	ND LOCATIONAL GUARD PE 'SO' COFF LEXIBLE S' ABOVE SCH	ON OF A PRIOR PAND FEEL CO	TO ROUGHING PLUG TO NDUIT DO NOT EET FSIØI,	LV. DATED	
PANEL '	· · -			DI	JUBLE	PANEL - SEC	CTION I			10,000 A. I. C. FUL		
	QOD', BOLT-ON 225 AMP MAIN LUGS									120/208 VOLT, 3 PHASE	, 4 WIRE M□UNTED	
BBKB		ND. ND.	CIDCUIT		PЦ	ASE LOAD -	<u></u> VΔ	CIRCUIT	ИП ИП		BRKR	CIR
P AMPS		TS REC			SE A	PHASE B	PHASE C	LOAD	REC LTS	DESCRIPTION	P AMPS	
4 00	L TO DIVITUE	_ + +	4 440		4 0 40			 			+ . +	+

	28		27	-	-	_		1	575		3, 075		2, 500	
20	30		29	-	-	-			575			575		
	32		31	3	15	MAKE-UP AIR UNIT MA/1			830	1,430			600	
	34		33	-	-	-			830		1,430		600	
	36		35	-	-	_			830			1, 430	600	
	38		37	1		SPACE				0				
	40		39	1		SPACE					0			
	42		41	1		SPACE						0		
								SE	CTION II	9, 925	9, 450	8, 030		
							SEC	TION	II & I ZI	20, 695	20, 095	19, 275		
					TOTAL	_ CONNECTED LOADS:		S	ECTION I:	27, 405	VA	76 AMPS		F
		•					SEC	TION	:II & I Z	60,065	VA	167 AMPS		
						CALCULATED FEEDER	DEMA	AND,	NEC 220:	57, 969	VA	161 AMPS		

* SHUNT TRIP CIRCUIT BREAKER WITH 120 VAC COIL. INTERLOCK WITH HOOD FIRE SUPPRESSION SYSTEM. SEE EXHAUST HOOD CONTROL WIRING DIAGRAM, SHEET E-601.

SYMBOL LIST

NEW FLUORESCENT FIXTURE WITH EMERGENCY LIGHTING BATTERY PACK

NEW EMERGENCY LIGHTING UNIT INDICATING NUMBER OF LAMP HEADS

NEW REMOTE EMERGENCY LIGHT FIXTURE INDICATING NUMBER OF LAMP HEADS

NEW EXIT LIGHT WITH ARROW INDICATING DIRECTION OF EXIT

FIXTURE WITH LETTER INDICATING CONTROLLING SWITCH

SWITCH WITH LETTER INDICATING CONTROLLED FIXTURES

SYMBOL

 \circ

Ю

0

 \bigcirc

 \mathcal{K}

 \bigcirc

Oa

 \Rightarrow

⊕GFI

⊏ղ⊧

 \boxtimes

 \boxtimes

ርጋን

(Ī)

F-2

● 6-30R

DESCRIPTION

NEW CEILING MOUNTED FIXTURE

EXISTING CEILING MOUNTED FIXTURE

EXISTING WALL MOUNTED FIXTURE

EXISTING FLUORESCENT FIXTURE

EXISTING RECESSED FIXTURE

EXISTING EXIT LIGHT

NEW SINGLE POLE SWITCH

NEW OCCUPANCY SENSOR WALL SWITCH

NEW OCCUPANCY SENSOR SWITCHPACK

NEW AREA OCCUPANCY SENSOR

EXISTING SINGLE POLE SWITCH

NEW THREE WAY SWITCH

NEW PHOTOCELL

NEW JUNCTION BOX

EXISTING JUNCTION BOX

NEW DUPLEX RECEPTACLE

NEW DOUBLE DUPLEX RECEPTACLE

EXISTING DUPLEX RECEPTACLE

NEW TELEPHONE/DATA OUTLET

EXISTING TELEPHONE OUTLET

EXISTING BRANCH CIRCUIT

NEW EXISTING MOTOR

EXISTING THERMOSTAT

KEYED NOTE SYMBOL

FIXTURE SCHEDULE SYMBOL

EXISTING DISCONNECT SWITCH

NEW MOTOR

EXISTING DOUBLE DUPLEX RECEPTACLE

NEW OUTLET WITH GROUND FAULT CIRCUIT INTERRUPTER

NEW POWER PANELBOARD, 120/208 VOLT, 3 PHASE

EXISTING POWER PANELBOARD, 120/240 VOLT, 1 PHASE

NEW BRANCH CIRCUIT EXPOSED ON WALL OR CEILING

NEW MAGNETIC MOTOR STARTER OR CONTROL PANEL

EXISTING EVAPORATIVE COOLER CONTROL SWITCH

DETAIL OR SECTION DESIGNATION BY SHEET COORDINATES

INDICATES ITEM IN WEATHERPROOF (NEMA 3R MINIMUM) ENCLOSURE

MECHANICAL EQUIPMENT SCHEDULE SYMBOLS

SHEET ON WHICH DETAIL OR SECTION IS SHOWN

NEW BRANCH CIRCUIT CONCEALED IN FLOOR, WALL, OR CEILING

NEW STARTER OR CONTROL PANEL WITH INTEGRAL DISCONNECT

NEW SPECIAL PURPOSE RECEPTACLE INDICATING NEMA DESIGNATION

NEW 3 PHASE, 4 WIRE HOMERUN INDICATING PANEL AND CIRCUIT NUMBERS

NEW DISCONNECT SWITCH, 'F' INDICATES FUSED, 'NF' INDICATES NON-FUSED

NEW MANUAL MOTOR STARTING SWITCH W/ THERMAL OVERLOAD PROTECTION

NEW WALL MOUNTED FIXTURE

NEW FLUORESCENT FIXTURE

1 | 1,080 | 1,440 |

1,440

1,405

575

1 1,405

1,500

SHEET

